
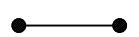
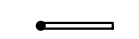
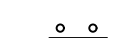










06 - TRAFFIC INDEX OF DRAWINGS

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THE INFORMATION, INCLUDING ESTIMATED QUANTITIES OF WORK, SHOWN ON THESE SHEETS IS BASED ON LIMITED INVESTIGATIONS BY THE STATE AND IS IN NO WAY WARRANTED TO INDICATE THE CONDITIONS OF ACTUAL QUANTITIES OF WORK WHICH WILL BE REQUIRED.		DESIGNER/DRAFTER: M. DION CHECKED BY: R. GOMEZ		 STATE OF CONNECTICUT DEPARTMENT OF TRANSPORTATION		PROJECT TITLE: I-84 INTERCHANGES 5 & 6 IMPROVEMENTS		TOWN: DANBURY		PROJECT NO. 34-313	
ENGINEER: AECOM USA INC. / VN ENGINEERS, Inc.		DRAWING TITLE: TRAFFIC DRAWINGS INDEX		DRAWING NO. TR-01		SHEET NO. 06.01		APPROVED BY: SOPIA NIRSHBERG, PE		DATE: 03/28/2014	

SIGNING STANDARD CONVENTIONS			
	OVERHEAD INSTALLATION		
	CANTILEVER INSTALLATION		
	SIDE MOUNTED INSTALLATION		
	SINGLE POST MOUNTING	REGULATORY, WARNING OR GUIDE SIGN INSTALLATION	
	DOUBLE POST MOUNTING		
	AS NOTED - (16H,16E CONSTRUCTION IDENTIFICATION SIGNS)		
	SIDE MOUNTED EXTRUDED ALUMINUM SIGN		
	SINGLE POST MOUNTING SHEET ALUMINUM BACK TO BACK		
	DOUBLE POST MOUNTING SHEET ALUMINUM BACK TO BACK		
	SIDE MOUNTED EXTRUDED ALUMINUM SIGN BACK TO BACK		
	DIRECTION OF TRAVEL		
<div>00-000-00</div>		LOCATION NO.	
<div>0</div>		EXTRUDED ALUMINUM SIGNS	
<div>00 00-0</div>	LOCATION NO.		
	SIGN NO.		

SIGNING NOTES:

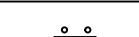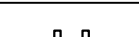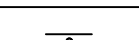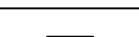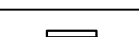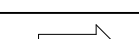ALL SIGNS SHALL BE NEW UNLESS OTHERWISE NOTED.

ALL EXISTING SIGNS LOCATED WITHIN THE SIGNING LIMITS SHALL BE REMOVED UNLESS OTHERWISE SPECIFIED (EXCLUDING OVERHEAD AND BRIDGE MOUNTED SIGNS) . THIS WORK SHALL BE PAID UNDER THE CONTRACT ITEM NO. 1206023A "REMOVAL AND RELOCATION OF EXISTING SIGNS"

ALL CHEVRON SIGNS (SIGN NO. 41-4203) TO HAVE A YELLOW FLOURESCENT STRIP (SIGN NO. 41-5001) INSTALLED ON THE SIGN POST. SIGN NO. 41-5001 IS TO BE PAID FOR UNDER ITEM NO. 1208928-SIGN FACE-SHEET ALUMINUM (TYPE III REFLECTIVE SHEETING.

ALL EXISTING OVERHEAD SIGNS LOCATED WITHIN THE SIGNING LIMITS SHALL BE REMOVED UNLESS OTHERWISE NOTED. WORK SHALL BE PAID UNDER THE CONTRACT ITEM NO. 1206025A - "REMOVAL OF EXISTING OVERHEAD SIGNING."

ALL EXISTING SIGNS NOTED TO BE RELOCATED SHALL BE INSTALLED ON NEW BREAKAWAY SUPPORTS AND NEW FOUNDATIONS, UNLESS OTHERWISE NOTED. THIS WORK SHALL BE PAID UNDER THE CONTRACT ITEM NO.1206023A "REMOVAL AND RELOCATION OF EXISTING SIGNS".

ALL TOWN OWNED SIGNS INCLUDING STREET NAME SIGNS SHALL BE RELOCATED AS DIRECTED BY THE ENGINEER. THIS WORK SHALL BE PAID UNDER THE CONTRACT ITEM NO. 1206023A "REMOVAL AND RELOCATION OF EXISTING SIGNS"

ALL EXISTING SIGNS OUTSIDE THE LIMIT OF SIGNING ARE TO REMAIN UNLESS OTHERWISE NOTED ON THE PLANS OR AS DIRECTED BY THE ENGINEER.

SIGNS SHALL BE INSTALLED IN ACCORDANCE WITH STANDARD SHEETS TR-1208-01 - SIGN SUPPORT AND SIGN PLACEMENT DETAILS, GORE EXIT SIGN AND TR-1208-02 - METAL SIGN POSTS AND SIGN MOUNTING DETAILS UNLESS OTHERWISE NOTED.

SIGNS SHALL BE INSTALLED NO CLOSER THAN 10 FEET FROM UTILITY POLES. UTILITY POLE LOCATIONS SHOWN ON PLANS ARE APPROXIMATE. SEE UTILITY PLANS FOR EXACT LOCATIONS.

FINAL SIGN LOCATIONS SHALL BE VERIFIED BY ENGINEER.

THE RELATIVE LOCATION OF EACH SIGN ON OVERHEAD STRUCTURES IS SHOWN READING ALPHABETICALLY FROM LEFT TO RIGHT, AS VIEWED BY TRAFFIC.

THE CONTRACTOR SHALL CLEAR AND TRIM AS DIRECTED BY THE ENGINEER TO PROVIDE ADEQUATE SIGHT DISTANCE TO ALL SHEET ALUMINUM SIGNS AND ALL EXTRUDED ALUMINUM SIGNHS. THIS WORK SHALL BE PAID FOR UNDER ITEM NO. 0952001A - "SELECTIVE CLEARING AND THINNING."

ALL OBJECT MARKERS WITHIN PROJECT LIMITS ARE TO BE REPLACED. THIS WORK WILL BE PAID FOR UNDER ITEM NO. 0930001 - "OBJECT MARKER."

THE CONTRACTOR SHALL INSTALL TYPE DE-1 AND DE-2 DELINEATORS IN ACCORDANCE WITH STANDARD SHEET TR-1205-01 "DELINEATION, DELINEATOR AND OBJECT MARKER DETAILS."

SIGNS NOT IN CONTRACT (N.I.C.) SHALL BE REMOVED AND RELOCATED BY OWNER(S)

"ONE WAY" SIGNS TO BE MOUNTED 1' ABOVE ADJACENT "DO NOT ENTER SIGNS". IF NEARBY GUIDE SIGNS WILL BLOCK VISIBILITY TO THE "ONE WAY" SIGNS, THE HEIGHT OF THE "ONE WAY" SIGNS SHALL BE INCREASED ACCORDINGLY.


STATE AND TOWN OWNED GUIDE SINGS IN THE VICINITY OF THE OFF RAMP SHOULD NOT BE LOCATED IN A MANNER THAT COULD CAUSE THE MOTORIST TO ENTER THE OFF RAMP.

"DO NOT ENTER" AND "WRONG WAY" SIGNS ARE TO HAVE A REFLECTIVE RED STRIP (SIGN NO. 31-5003) INSTALLED ON THE SIGN POST.

SIGNS "DO NOT ENTER" (31-1121) AND "WRONG WAY" (31-1123) TO BE MOUNTED 5' OFF OF THE GROUND MEASURED FROM THE BOTTOM OF THE SIGN.

"DO NOT ENTER: (31-1121) AND "STOP" SIGNS TO BE INSTALLED A MINIMUM OF 2' FROM EACH OTHER WHEN FEASIBLE.

▲ SPAN MOUNTED SIGN. PLEASE SEE TRAFFIC SIGNAL PLANS FOR EXACT LOCATION.

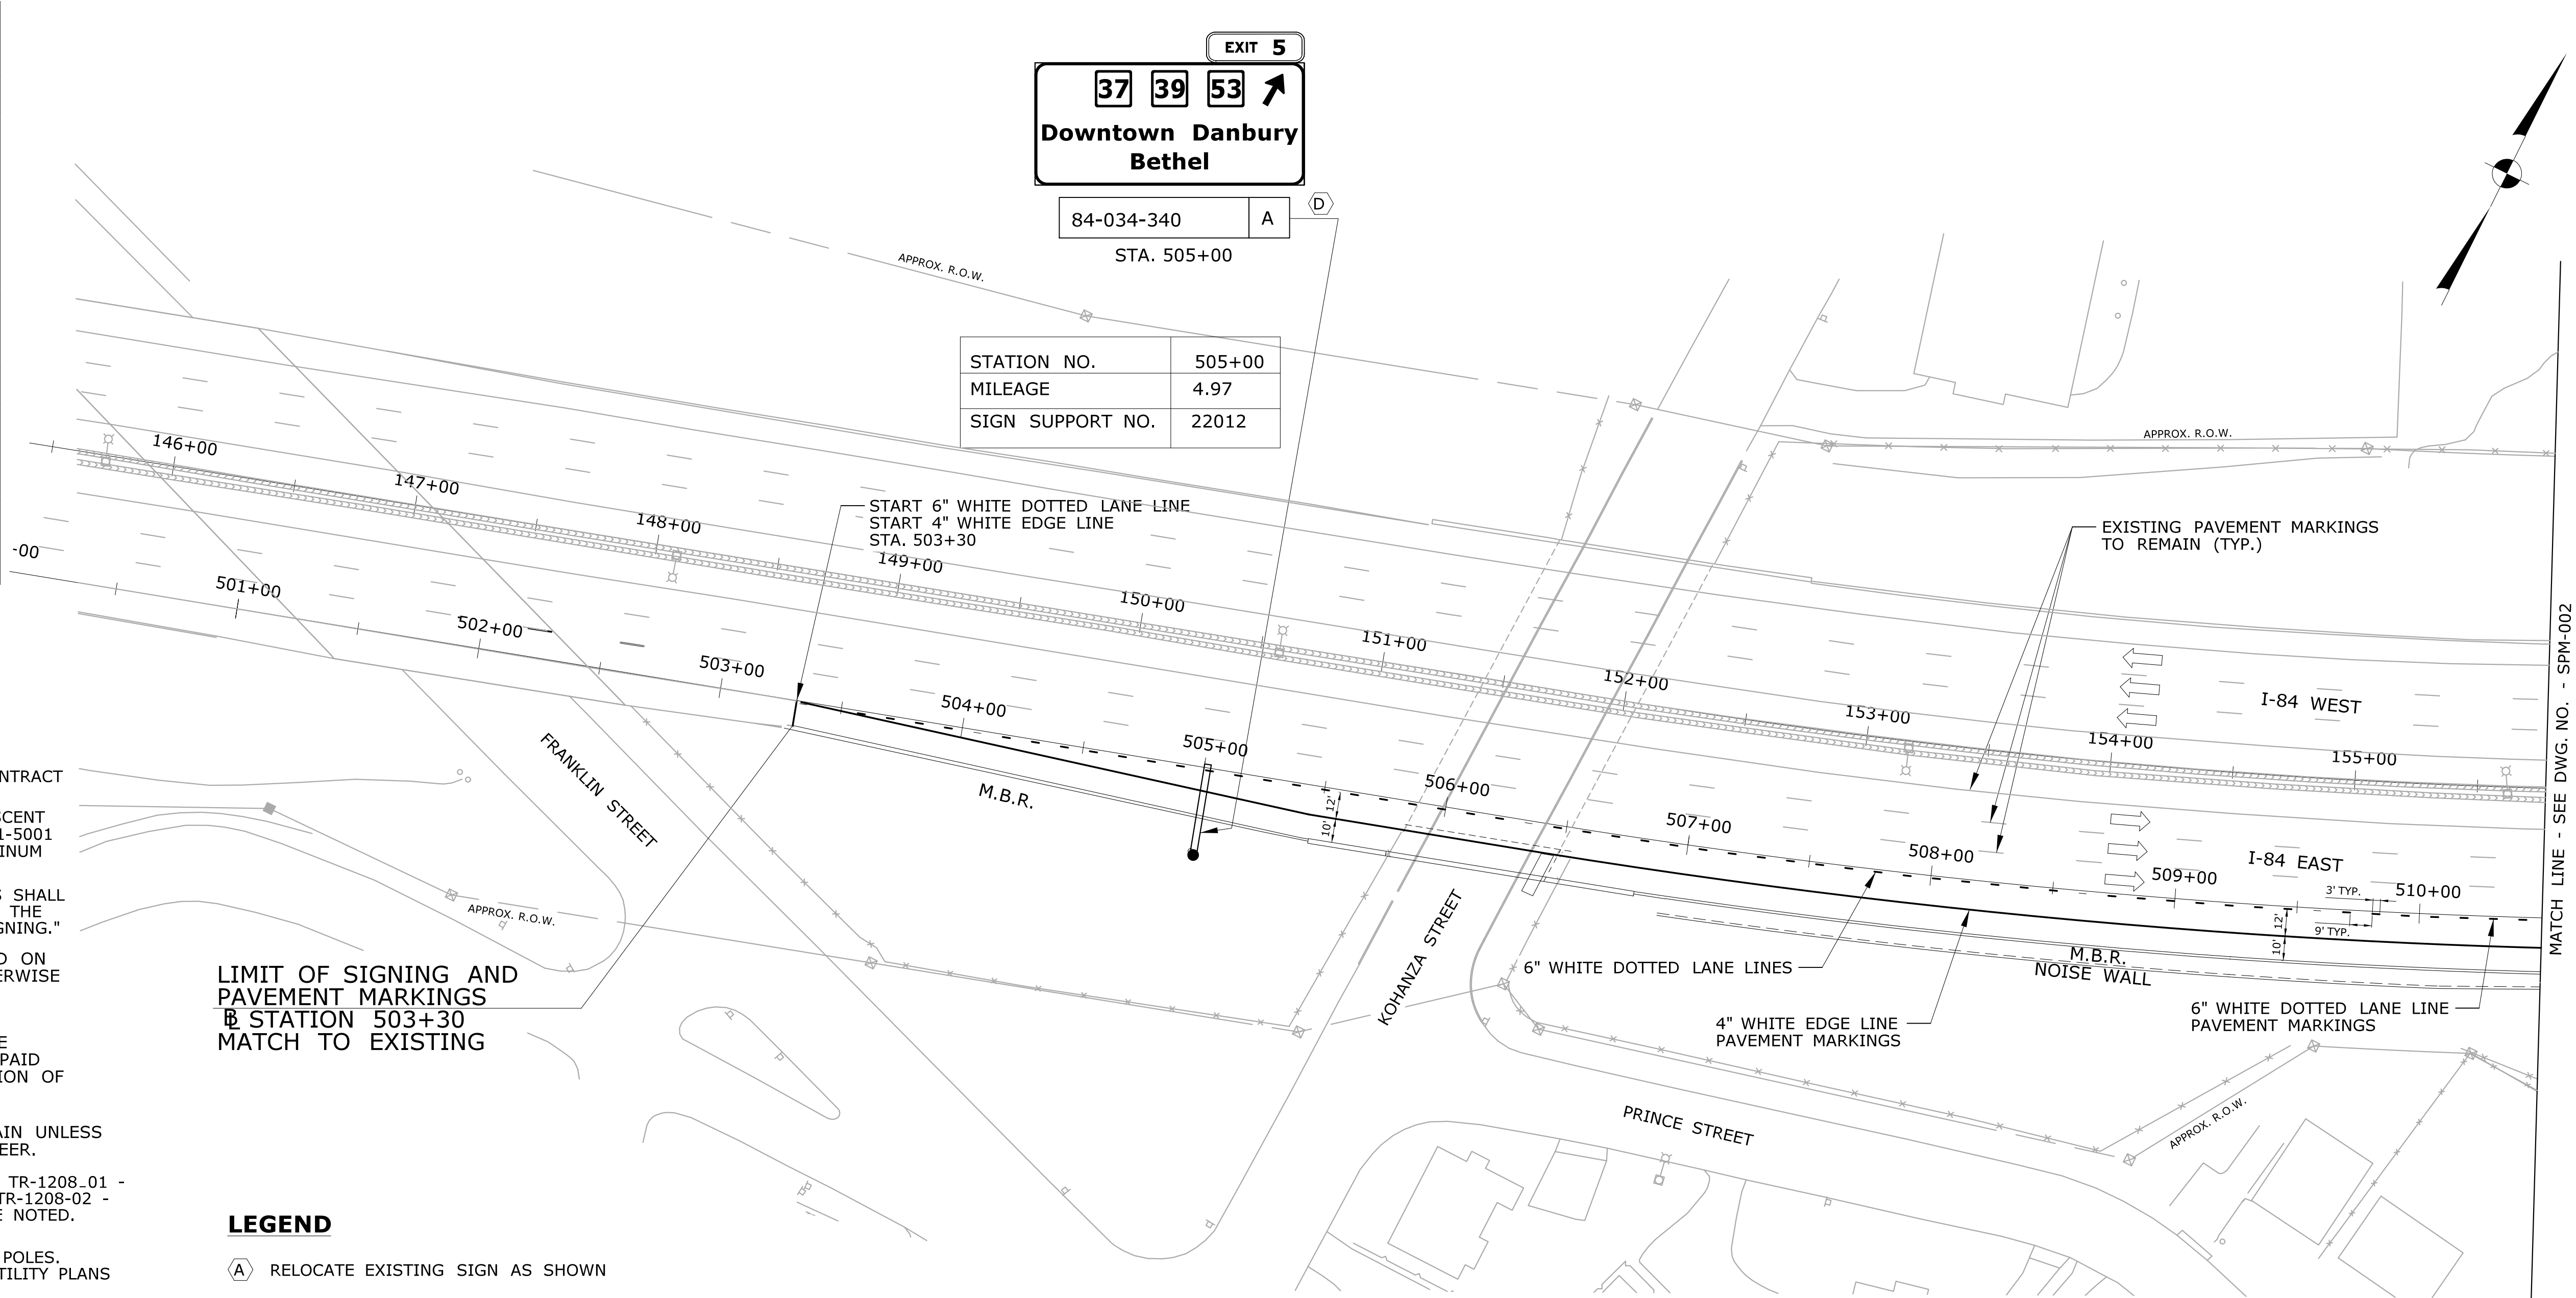

LIMIT OF SIGNING AND PAVEMENT MARKINGS @ STATION 503+30 MATCH TO EXISTING

LEGEND

- (A) RELOCATE EXISTING SIGN AS SHOWN
- (B) MODIFY EXISTING SIGN AS SHOWN
- (C) NEW SIDE MOUNT SIGN
- (D) EXISTING SIDE MOUNTED SIGN RELOCATED ONTO NEW OVERHEAD SUPPORT AND FOUNDATION. EXISTING SIDE MOUNTED SUPPORTS AND FOUNDATION TO BE REMOVED.
- (E) NEW OVERHEAD SIGN ON EXISTING SUPPORT AND FOUNDATION
- (F) REMOVE EXISTING OVERHEAD SIGN(S), SIGN SUPPORT AND FOUNDATION(S).
- (J) REMOVE SIGN AND POSTS FROM EXISTING LOCATION. INSTALL EXISTING SIGN ONTO NEW POSTS AT LOCATION SHOWN.
- (X) RELOCATE EXISTING SIGN(S) ONTO NEW POST AT A LOCATION APPROVED BY ENGINEER
- (S) INSTALL SCHOOL/ELDERLY AND HANDICAPPED BAR TYPE CROSSWALK (MAINTAINED BY STATE).
- (T) INSTALL SCHOOL/ELDERLY AND HANDICAPPED BAR TYPE CROSSWALK (MAINTAINED BY TOWN).
- (→) TRAVEL LANE AND DIRECTION OF TRAVEL

PAVEMENT MARKING NOTES:

STATE TO MAINTAIN ALL PAVEMENT MARKINGS AND SIGNING ON ROUTE 37, ROUTE I-84 MAINLINE AND ON/OFF RAMPs, AND STOP BARS AND STOP SIGNS ON SECOND AVENUE, WALNUT STREET, PADANARAM AVENUE, AND HAYESTOWN AVENUE, SR 841 (DOWNS ST.) AND STOP BAR ON FAIRVIEW AVENUE. CITY OF DANBURY TO MAINTAIN ALL OTHER PAVEMENT MARKINGS AND SIGNING ON CITY ROADS. DEVELOPERS TO MAINTAIN ALL PAVEMENT MARKINGS AND SIGNING ON PRIVATE DRIVES.

ALL FINAL PAVEMENT MARKINGS ARE TO BE EPOXY RESIN.

ALL PAVEMENT MARKINGS FOR TWO-WAY HIGHWAYS SHALL BE INSTALLED IN ACCORDANCE WITH STANDARD SHEET TR-1210-03 "SPECIAL DETAILS AND TYPICAL PAVEMENT MARKINGS FOR TWO-WAY HIGHWAYS" UNLESS OTHERWISE NOTED.

ALL PAVEMENT MARKINGS FOR DIVIDED HIGHWAYS SHALL BE INSTALLED IN ACCORDANCE WITH STANDARD SHEETS TR-1210-01 AND TR-1210-02 "PAVEMENT MARKINGS (DURABLE MARKINGS) FOR DIVIDED HIGHWAYS" UNLESS OTHERWISE NOTED.

PAVEMENT MARKINGS SHALL BE INSTALLED THROUGHOUT THE PROJECT TO THE LIMIT OF PAVEMENT MARKINGS OR AS DIRECTED BY THE ENGINEER. ALL CONFLICTING PAVEMENT MARKINGS WITHIN THE LIMIT OF CONSTRUCTION ARE TO BE REMOVED. THE REMOVAL OF PAVEMENT MARKINGS IS PAYABLE UNDER ITEM NO. 1211001 "REMOVAL OF PAVEMENT MARKINGS".

PAVEMENT MARKINGS DISTURBED WILL BE REINSTALLED USING CONSTRUCTION STAKING.

INSTALL SCHOOL/ELDERLY AND HANDICAPPED BAR TYPE CROSSWALK. SEE STANDARD SHEET TR-1210-03 - "SPECIAL DETAILS AND TYPICAL PAVEMENT MARKING FOR TWO-WAY HIGHWAYS".


ALL OFF RAMP STOP BARS TO BE 24" WIDE.

LANE USE ARROWS FOR OFF RAMPs ARE TO BE INSTALLED 10' FROM STOP BAR AS SHOWN. ADDITIONAL LANE USE ARROWS TO BE INSTALLED AS NEEDED PER DOT PAVEMENT MARKING STANDARDS.


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1	3/25/2014	Border Version	6/1/05

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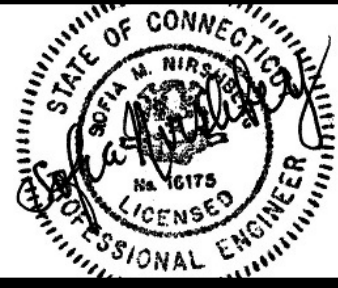
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CHECKED BY:	M. DION
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STATE OF CONNECTICUT
DEPARTMENT OF TRANSPORTATION

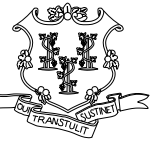


ENGINEER: AECOM USA, Inc. / VN ENGINEERS, Inc.
APPROVED BY: SOFIA NIRSHBERG, P.E.
DATE: 02/28/2014



PROJECT TITLE:	I-84 INTERCHANGES 5 & 6 IMPROVEMENTS
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TOWN:	DANBURY
DRAWING TITLE:	SIGNING AND PAVEMENT MARKING PLAN - I (INT 5)

PROJECT NO.	34-313
DRAWING NO.	SPM-001
SHEET NO.	06.02

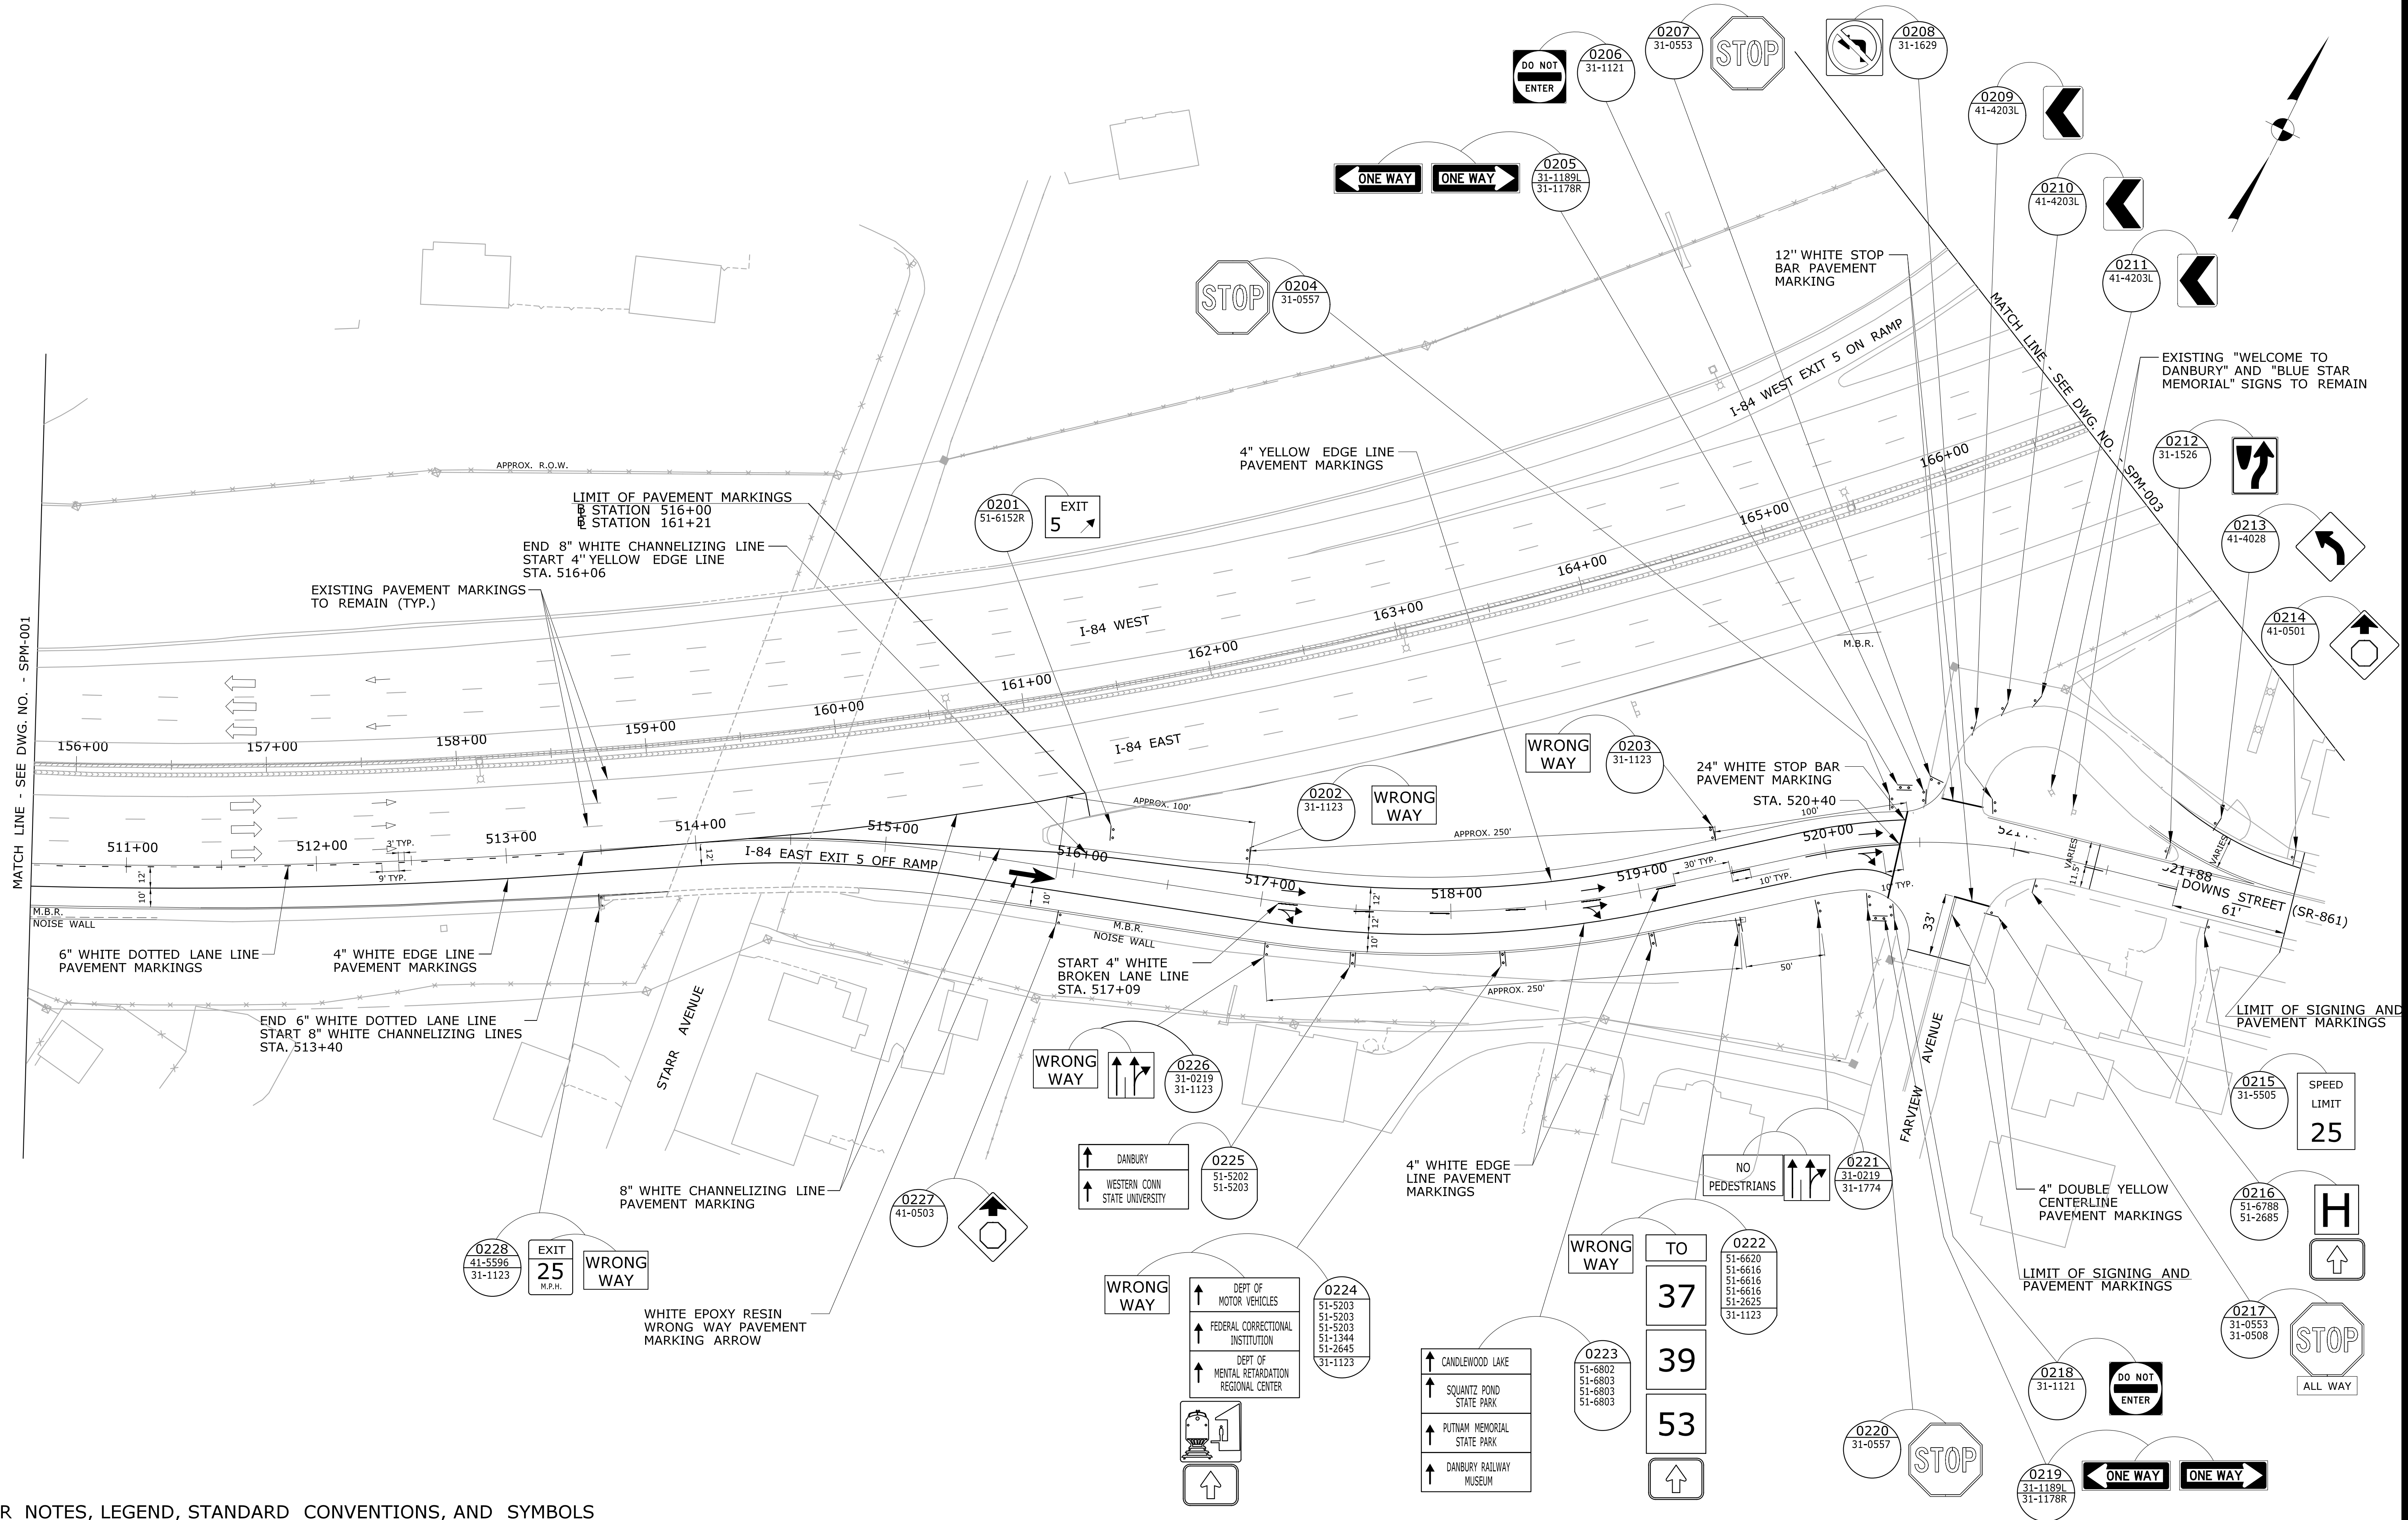

SEE SPM-001 FOR NOTES, LEGEND, STANDARD CONVENTIONS, AND SYMBOLS

REV.	DATE	REVISION DESCRIPTION	SHEET NO.
1	3/25/2014	Initial Design	1
2	6/1/05	Revised Design	2

Filename: TR_MSH_SPM-002_034_0308.dgn

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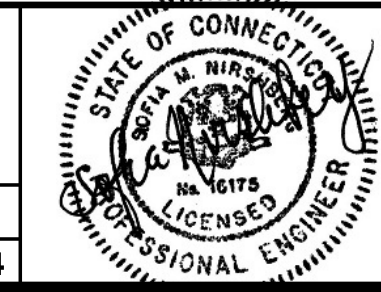
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CHECKED BY: M. DION
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STATE OF CONNECTICUT
DEPARTMENT OF TRANSPORTATION

ENGINEER: **AECOM USA, Inc. / VN ENGINEERS, Inc.**

APPROVED BY: **SOFIA NIRSHBERG, P.E.**


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PROJECT TITLE:
I-84 INTERCHANGES 5 & 6 IMPROVEMENTS

TOWN:
DANBURY
DRAWING TITLE:
SIGNING AND PAVEMENT MARKING PLAN - II (INT 5)

PROJECT NO.
34-313
DRAWING NO.
SPM-002
SHEET NO.
06.03


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DESIGNER/DRAFTER:
M. BAUER

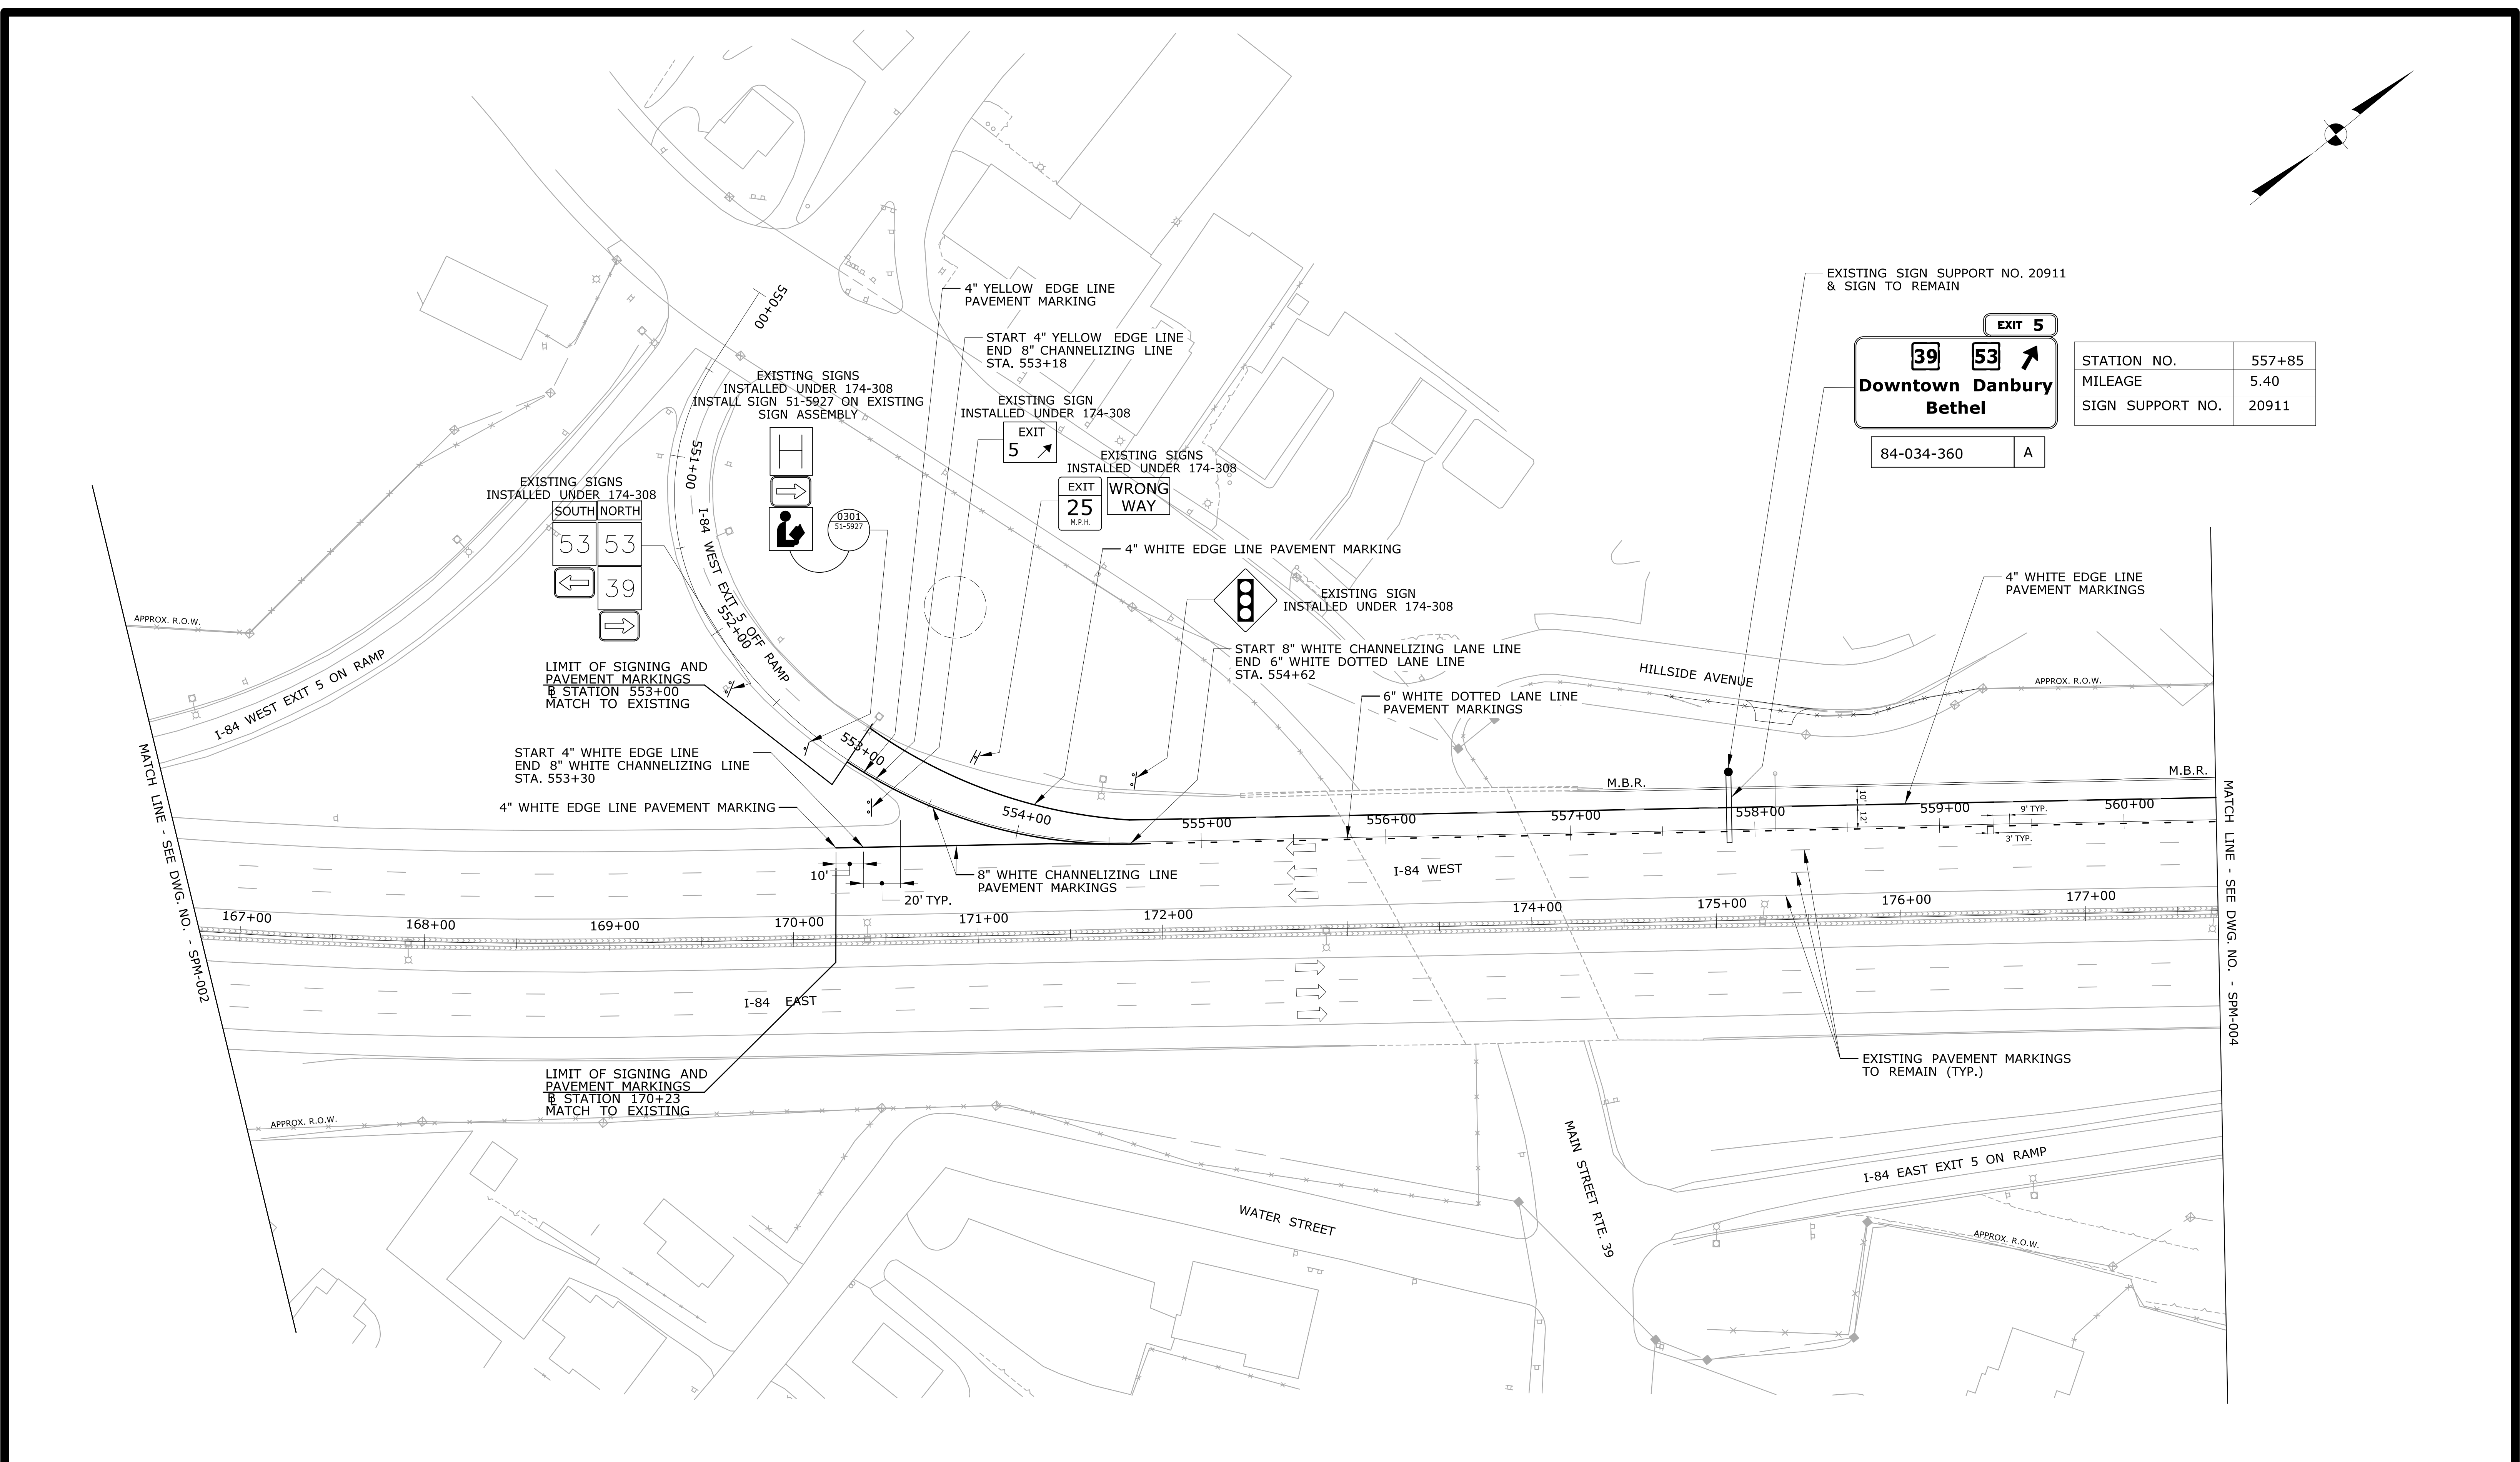

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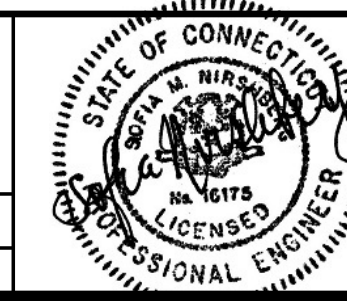


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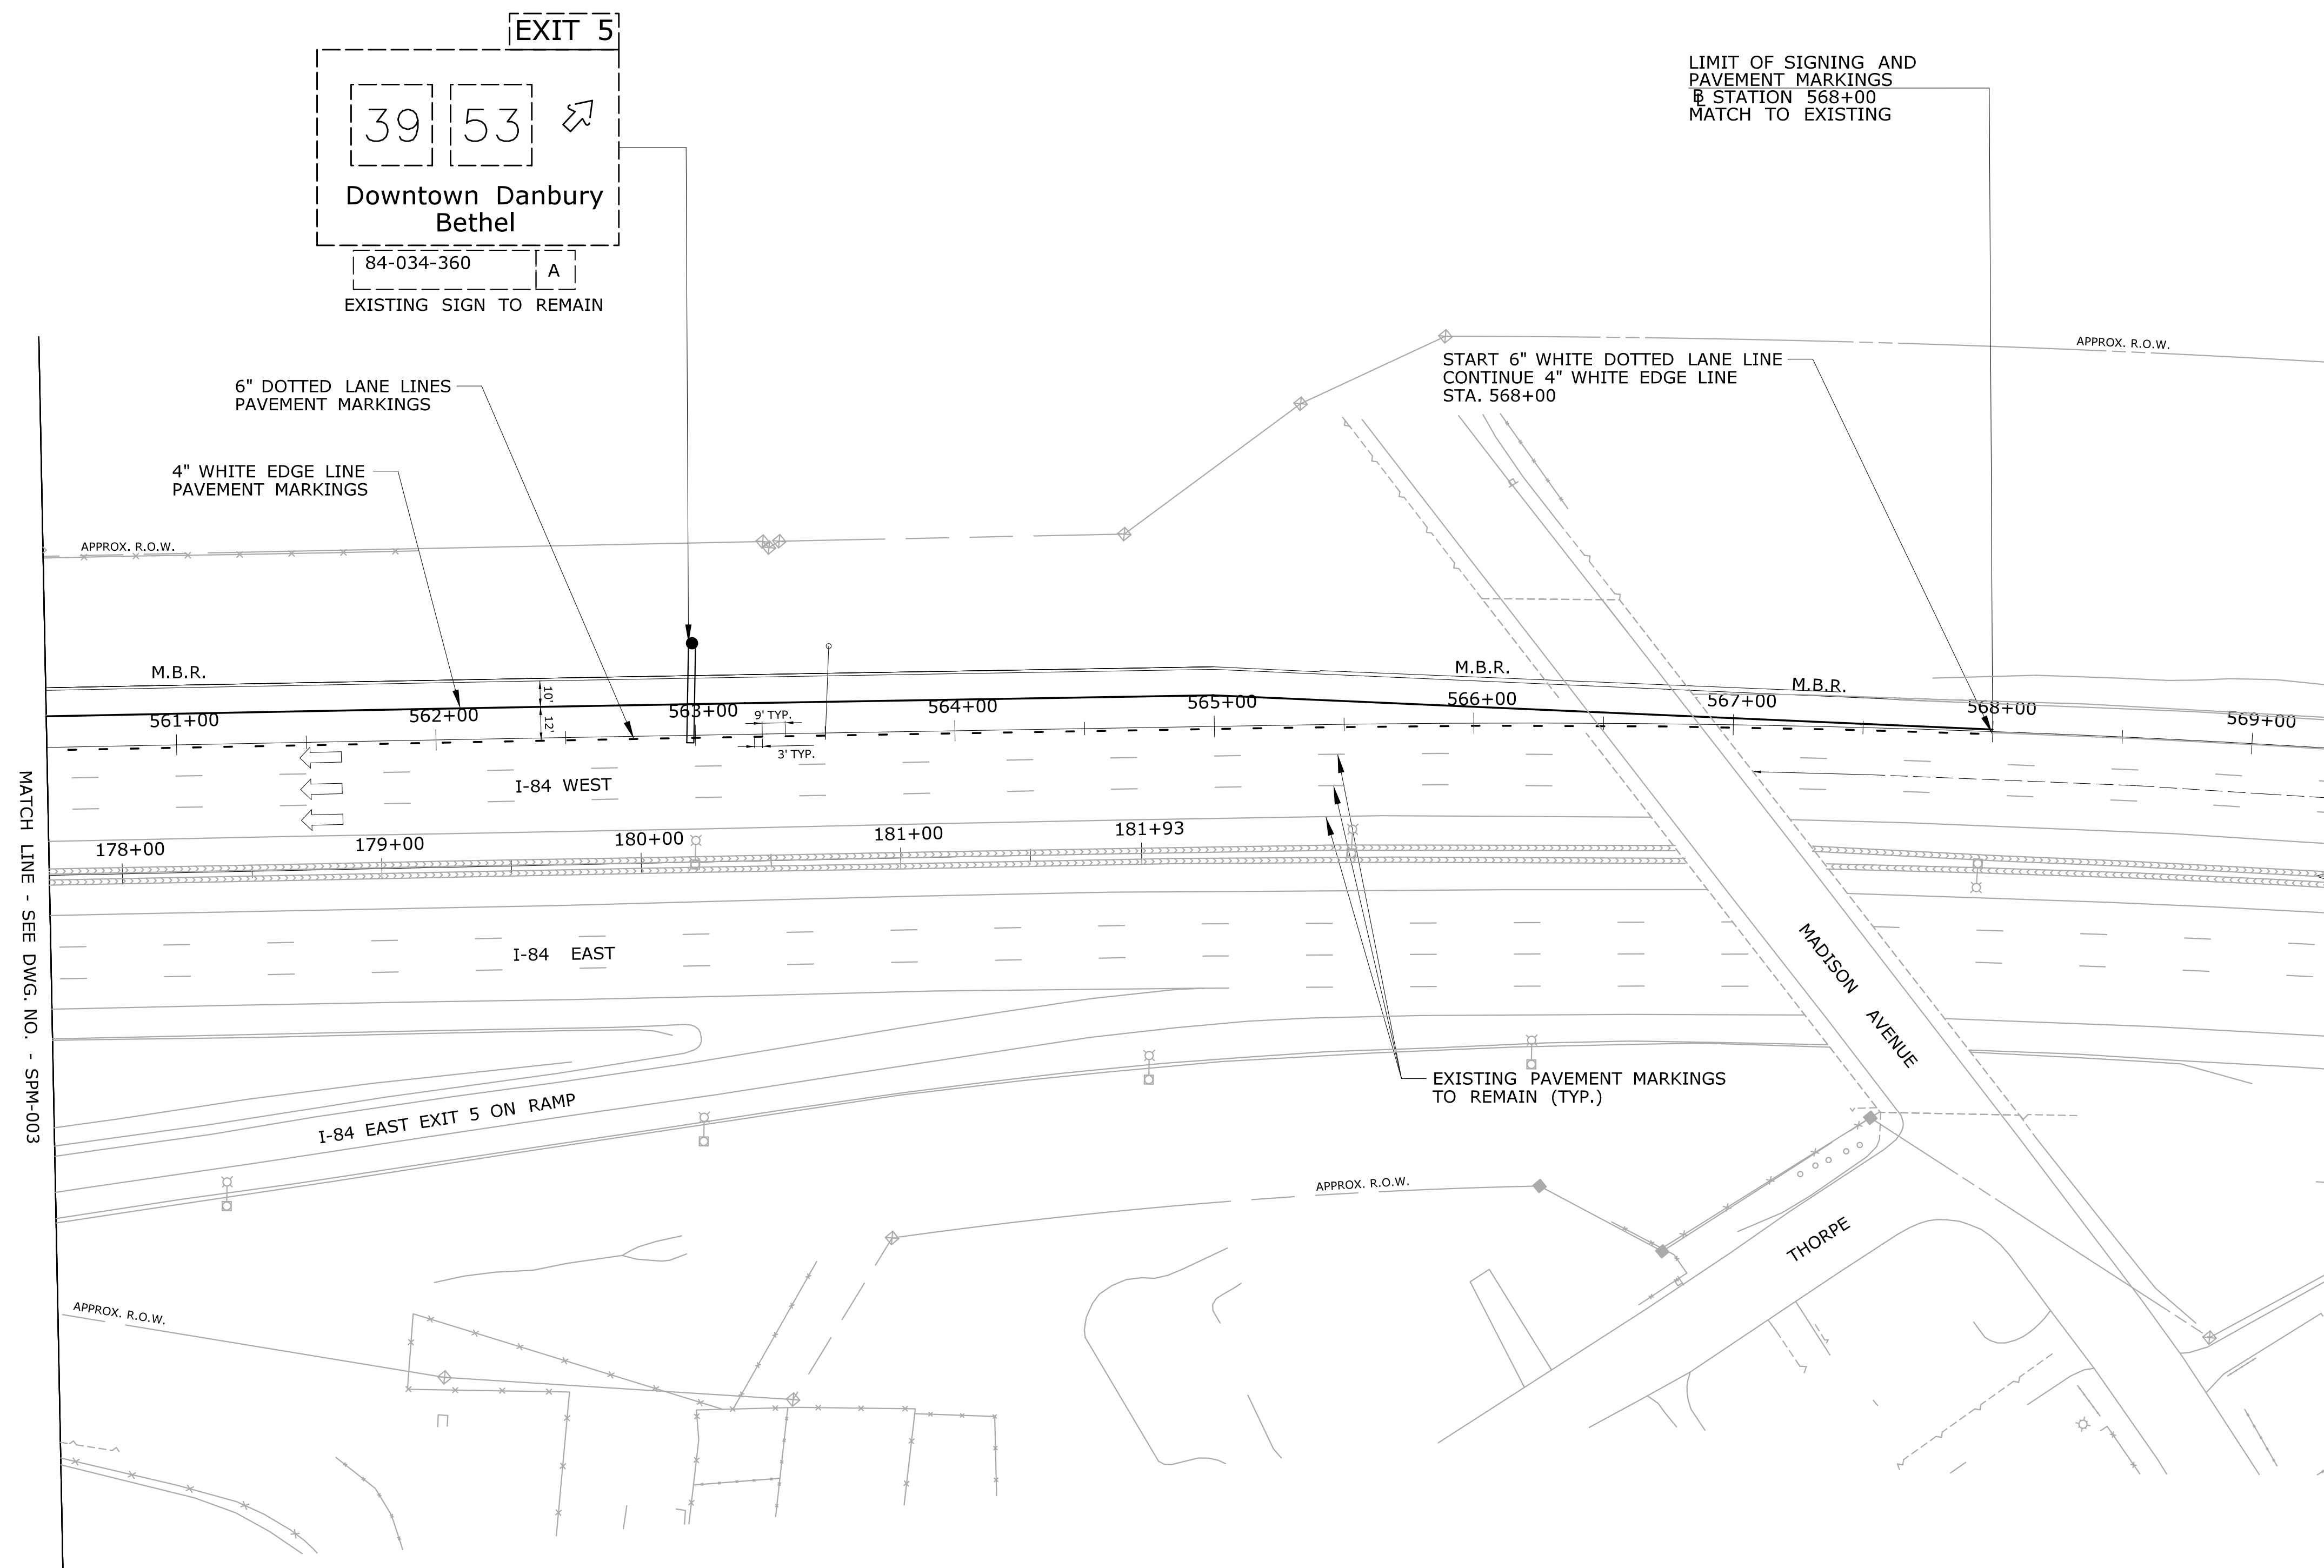
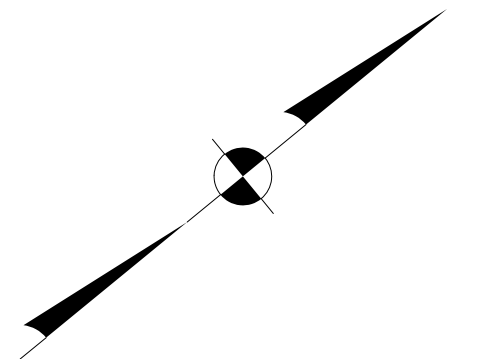

STATE OF CONNECTICUT
DEPARTMENT OF TRANSPORTATION


ENGINEER: **AECOM USA, Inc. / VN ENGINEERS, Inc.**
 APPROVED BY: **SOFIA NIRSHBERG, P.E.** DATE: **02/28/2014**







TOWN:	DANBURY
DRAWING TITLE:	SIGNING AND PAVEMENT MARKING PLAN - III (INT 5)

PROJECT NO.	34-313
DRAWING NO.	SPM-003
SHEET NO.	06.04

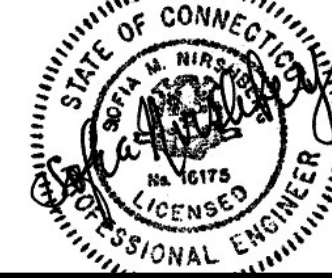

SEE SPM-001 FOR NOTES, LEGEND, STANDARD CONVENTIONS, AND SYMBOLS

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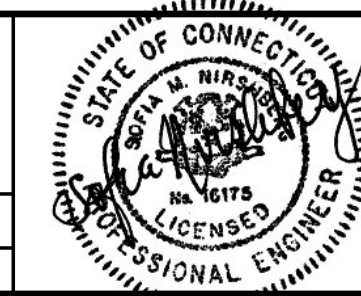
NOTES:
SEE SPM-001 FOR NOTES, LEGEND, STANDARD CONVENTIONS AND SYMBOLS.
SEE STRUCTURAL PLANS FOR DESIGN AND INSTALLATION OF STRUCTURE MOUNTED SIGNS.
INSTALL TYPE DE-9 DELINEATOR ON EACH POST OF SIGN NO. 41-4214.
SEE SMSS-001 AND SMSS-002 FOR STRUCTURAL DETAILS OF BRIDGE MOUNTED SIGNS.

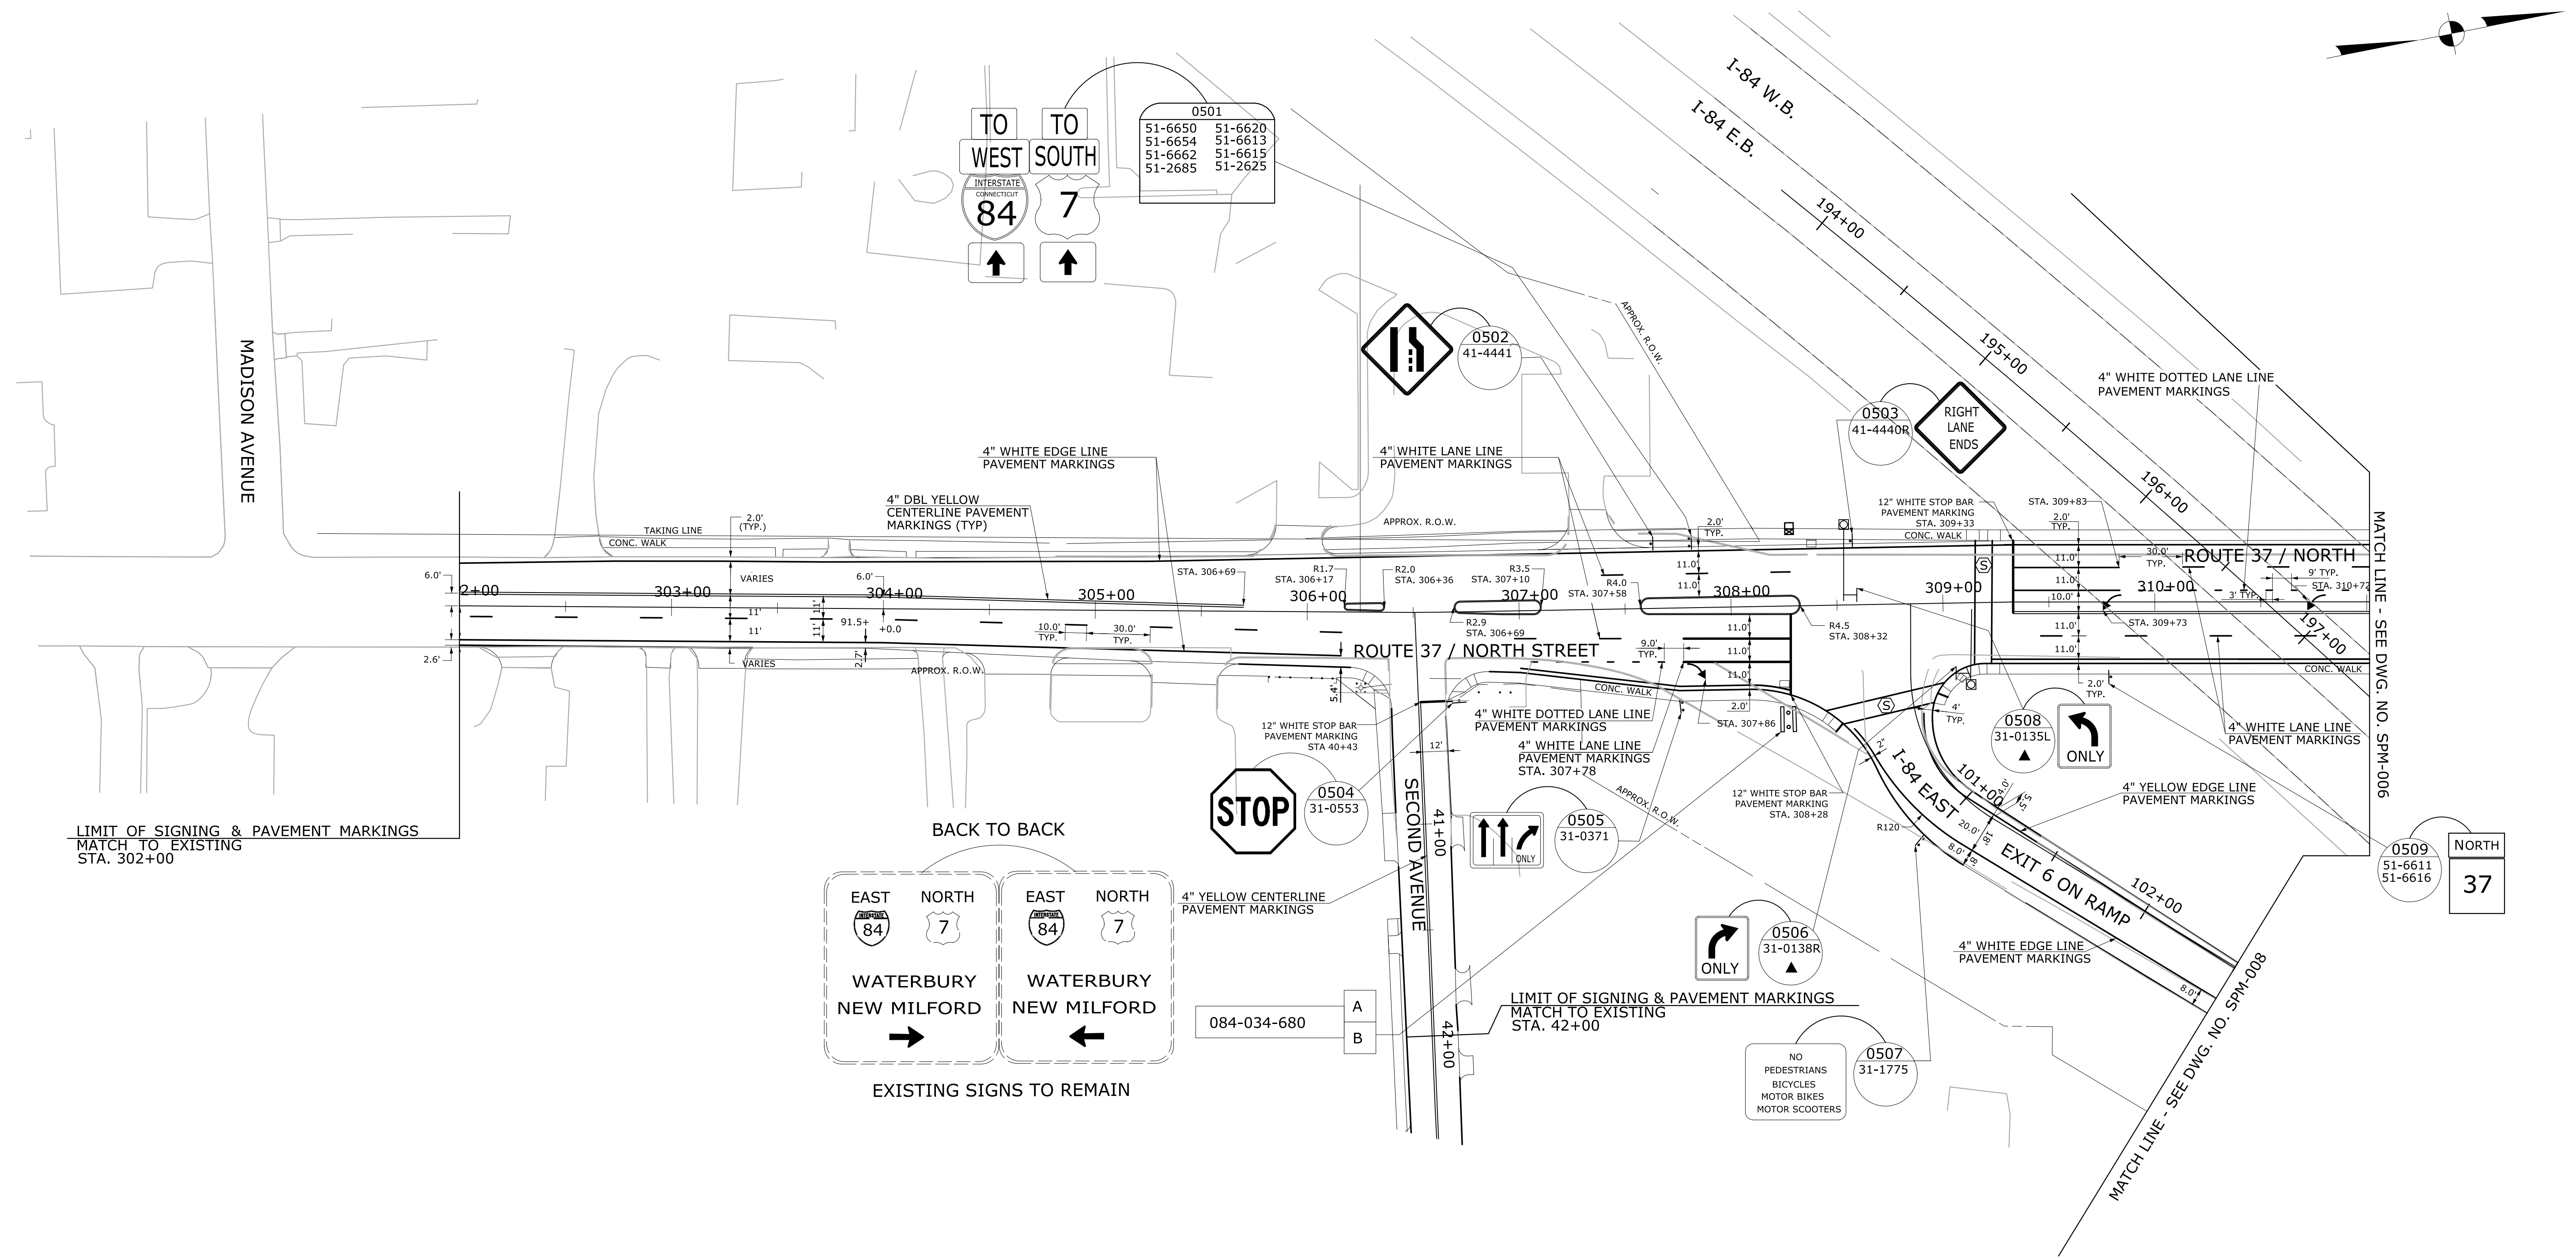REV.	DATE	REVISION DESCRIPTION	SHEET NO.
1	3/25/2014	Border Version	6/1705

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DESIGNER/DRAFTER:
M. DION
CHECKED BY:
R. GOMEZ
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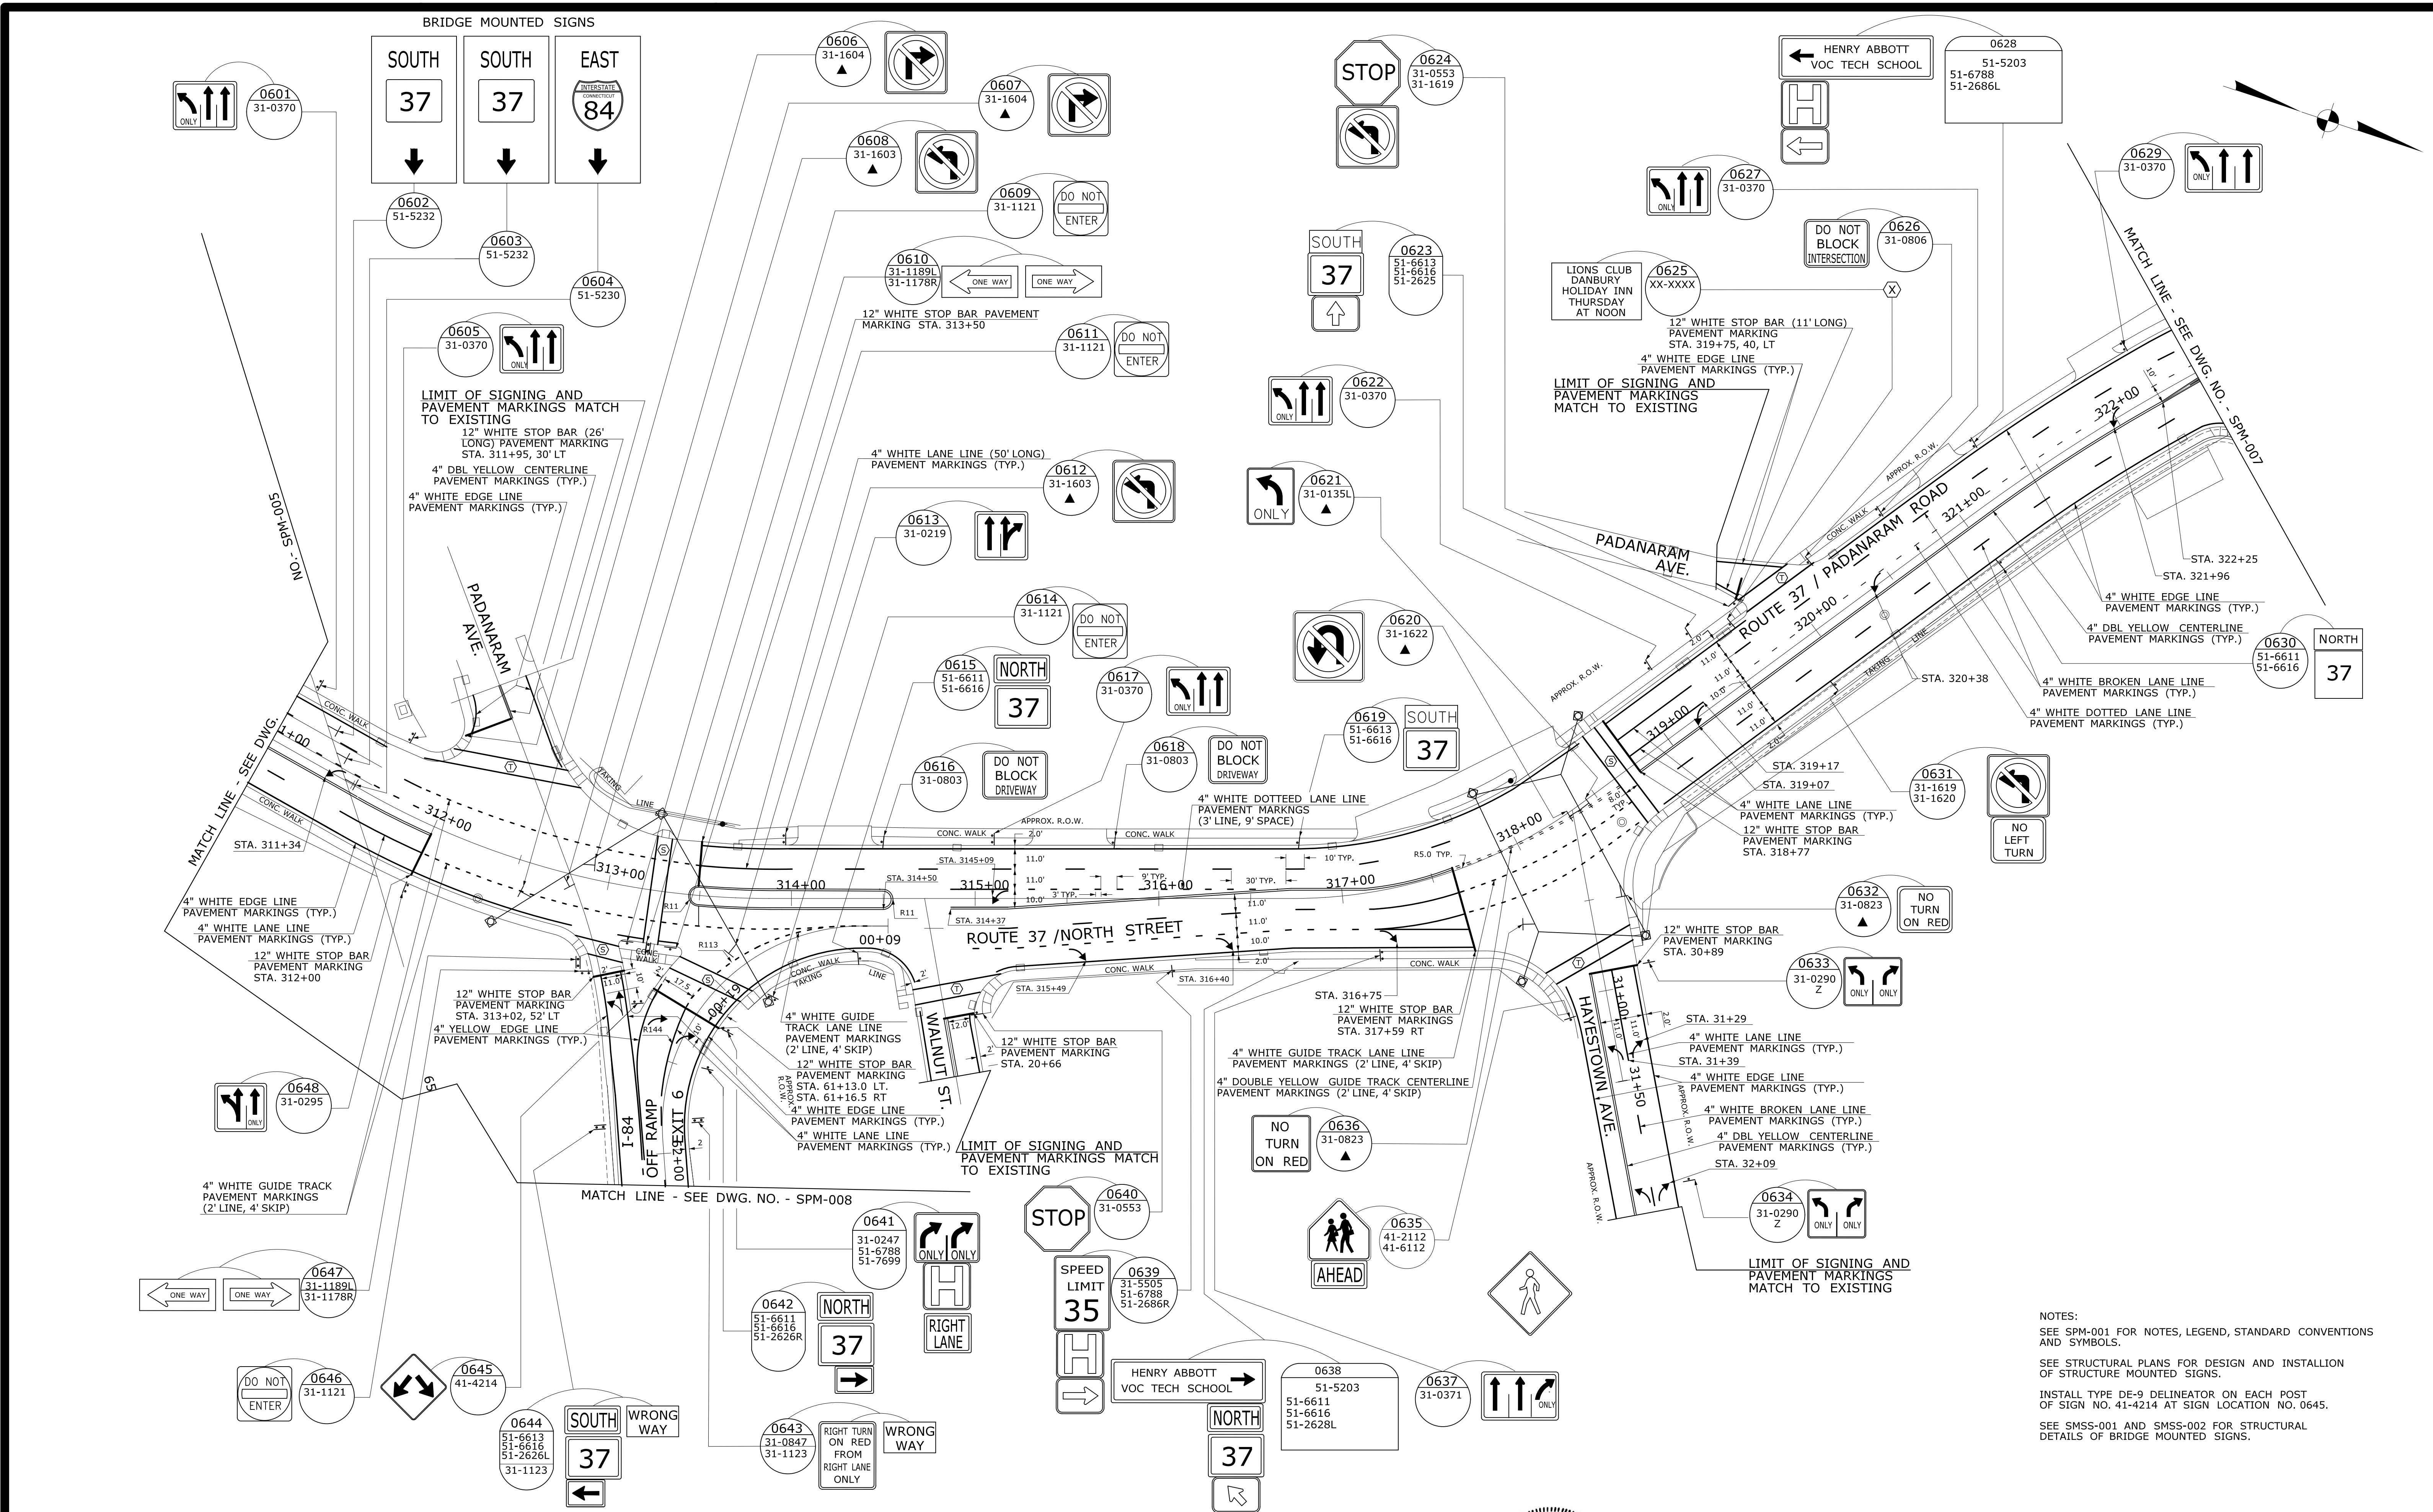
STATE OF CONNECTICUT
DEPARTMENT OF TRANSPORTATION
ENGINEER: **AECOM USA INC. / VN ENGINEERS, Inc.**
APPROVED BY: **SOPIA NIRSHBERG, PE**
DATE: 03/28/2014




PROJECT TITLE:
I-84 INTERCHANGES 5 & 6 IMPROVEMENTS

TOWN:
DANBURY
DRAWING TITLE:
SIGNING AND PAVEMENT MARKING PLAN - V (INT 6)

PROJECT NO.
34-313
DRAWING NO.
SPM-005
SHEET NO.
06.06





NOTES:
SEE SPM-001 FOR NOTES, LEGEND, STANDARD CONVENTIONS AND SYMBOLS.
SEE STRUCTURAL PLANS FOR DESIGN AND INSTALLATION OF STRUCTURE MOUNTED SIGNS.
INSTALL TYPE DE-9 DELINEATOR ON EACH POST OF SIGN NO. 41-4214 AT SIGN LOCATION NO. 0645.
SEE SMSS-001 AND SMSS-002 FOR STRUCTURAL DETAILS OF BRIDGE MOUNTED SIGNS.

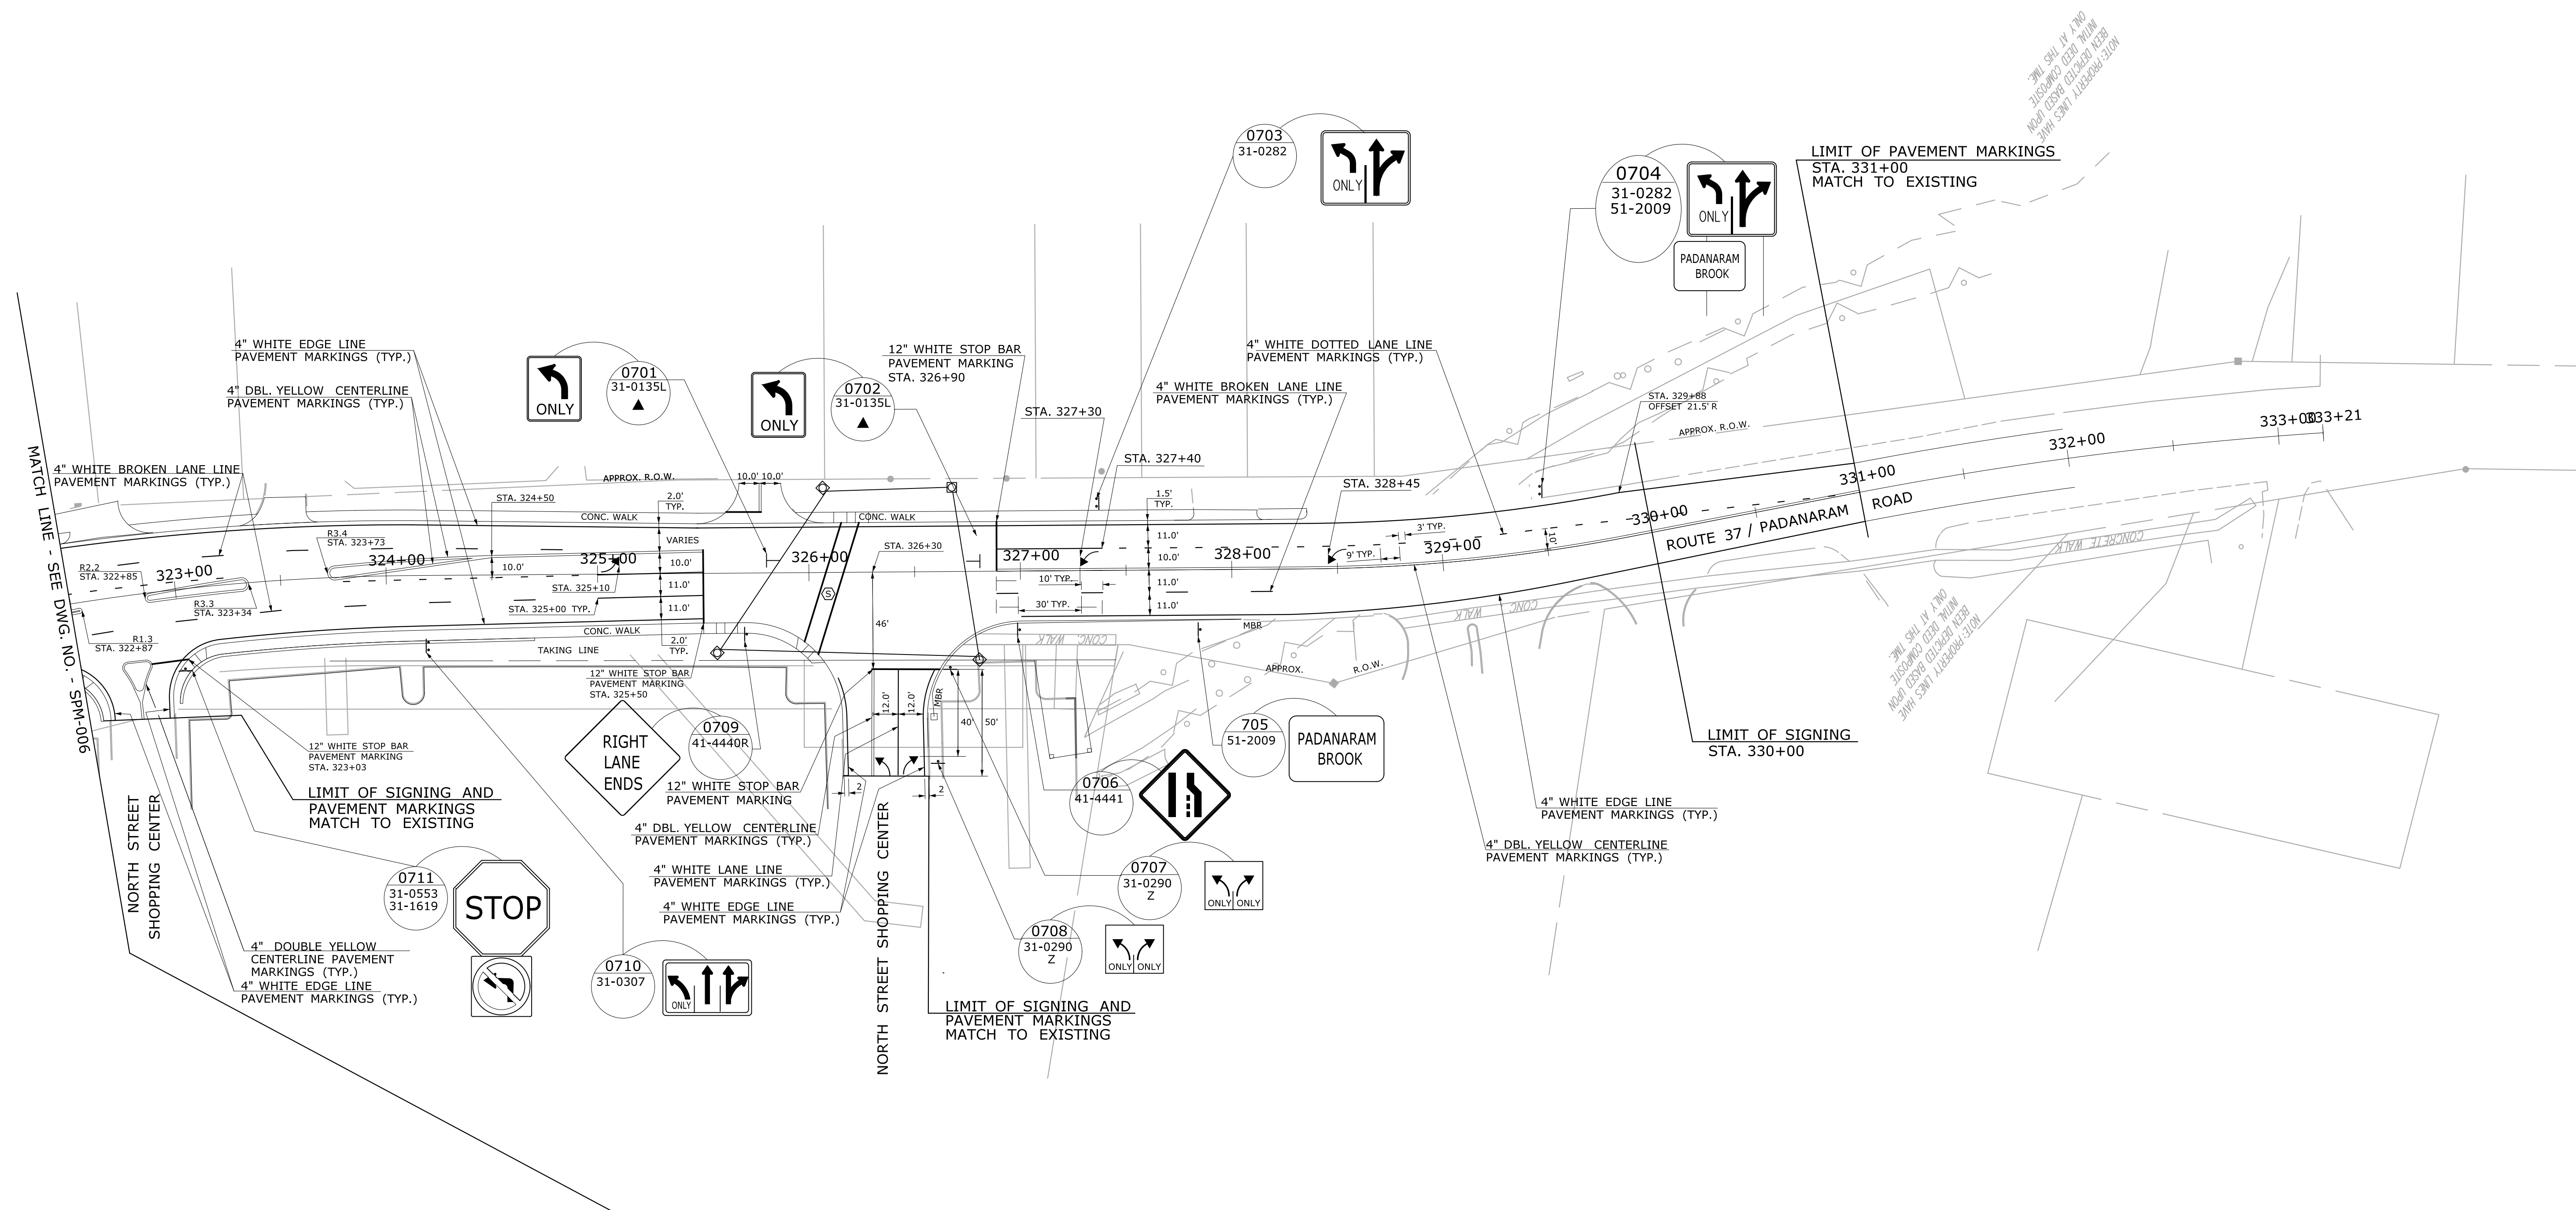

NOTES:
SEE SPM-001 FOR NOTES, LEGEND, STANDARD CONVENTIONS
AND SYMBOLS.

<table><tr><td>REV.</td><td>DATE</td><td>REVISION DESCRIPTION</td><td>SHEET NO.</td></tr><tr><td>1</td><td>3/25/2014</td><td>Border Version</td><td>6/17/05</td></tr></table>				REV.	DATE	REVISION DESCRIPTION	SHEET NO.	1	3/25/2014	Border Version	6/17/05	THE INFORMATION, INCLUDING ESTIMATED QUANTITIES OF WORK, SHOWN ON THESE SHEETS IS BASED ON LIMITED INVESTIGATIONS BY THE STATE AND IS IN NO WAY WARRANTED TO INDICATE THE CONDITIONS OF ACTUAL QUANTITIES OF WORK WHICH WILL BE REQUIRED.				<table><tr><td>DESIGNER/DRAFTER:</td><td colspan="3">M. DION</td></tr><tr><td>CHECKED BY:</td><td colspan="3">R. GOMEZ</td></tr><tr><td colspan="4"><table><tr><td colspan="2">SCALE IN FEET</td></tr><tr><td colspan="2"></td></tr><tr><td colspan="2">SCALE 1" = 40'</td></tr></table></td></tr></table>				DESIGNER/DRAFTER:	M. DION			CHECKED BY:	R. GOMEZ			<table><tr><td colspan="2">SCALE IN FEET</td></tr><tr><td colspan="2"></td></tr><tr><td colspan="2">SCALE 1" = 40'</td></tr></table>				SCALE IN FEET				SCALE 1" = 40'		<table><tr><td colspan="2"></td><td colspan="2">STATE OF CONNECTICUT DEPARTMENT OF TRANSPORTATION</td><td colspan="2"></td></tr><tr><td colspan="6">ENGINEER: AECOM USA INC. / VN ENGINEERS, Inc.</td></tr><tr><td colspan="4">APPROVED BY: SOPIA NIRSHBERG, PE</td><td colspan="2">DATE: 03/28/2014</td></tr></table>						STATE OF CONNECTICUT DEPARTMENT OF TRANSPORTATION				ENGINEER: AECOM USA INC. / VN ENGINEERS, Inc.						APPROVED BY: SOPIA NIRSHBERG, PE				DATE: 03/28/2014		<table><tr><td colspan="2"></td><td colspan="2">PROJECT TITLE: I-84 INTERCHANGES 5 & 6 IMPROVEMENTS</td></tr></table>						PROJECT TITLE: I-84 INTERCHANGES 5 & 6 IMPROVEMENTS		<table><tr><td colspan="2">TOWN: DANBURY</td><td colspan="2">PROJECT NO. 34-313</td></tr><tr><td colspan="2">DRAWING TITLE: SIGNING AND PAVEMENT MARKING PLAN - VII (INT 6)</td><td colspan="2">DRAWING NO. SPM-007</td></tr><tr><td colspan="2"></td><td colspan="2">SHEET NO. 06.08</td></tr></table>				TOWN: DANBURY		PROJECT NO. 34-313		DRAWING TITLE: SIGNING AND PAVEMENT MARKING PLAN - VII (INT 6)		DRAWING NO. SPM-007				SHEET NO. 06.08	
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1	3/25/2014	Border Version	6/17/05																																																																																
DESIGNER/DRAFTER:	M. DION																																																																																		
CHECKED BY:	R. GOMEZ																																																																																		
<table><tr><td colspan="2">SCALE IN FEET</td></tr><tr><td colspan="2"></td></tr><tr><td colspan="2">SCALE 1" = 40'</td></tr></table>				SCALE IN FEET				SCALE 1" = 40'																																																																											
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ENGINEER: AECOM USA INC. / VN ENGINEERS, Inc.																																																																																			
APPROVED BY: SOPIA NIRSHBERG, PE				DATE: 03/28/2014																																																																															
		PROJECT TITLE: I-84 INTERCHANGES 5 & 6 IMPROVEMENTS																																																																																	
TOWN: DANBURY		PROJECT NO. 34-313																																																																																	
DRAWING TITLE: SIGNING AND PAVEMENT MARKING PLAN - VII (INT 6)		DRAWING NO. SPM-007																																																																																	
		SHEET NO. 06.08																																																																																	

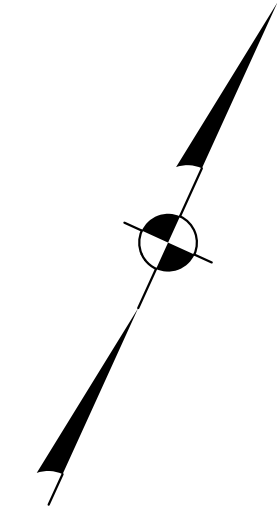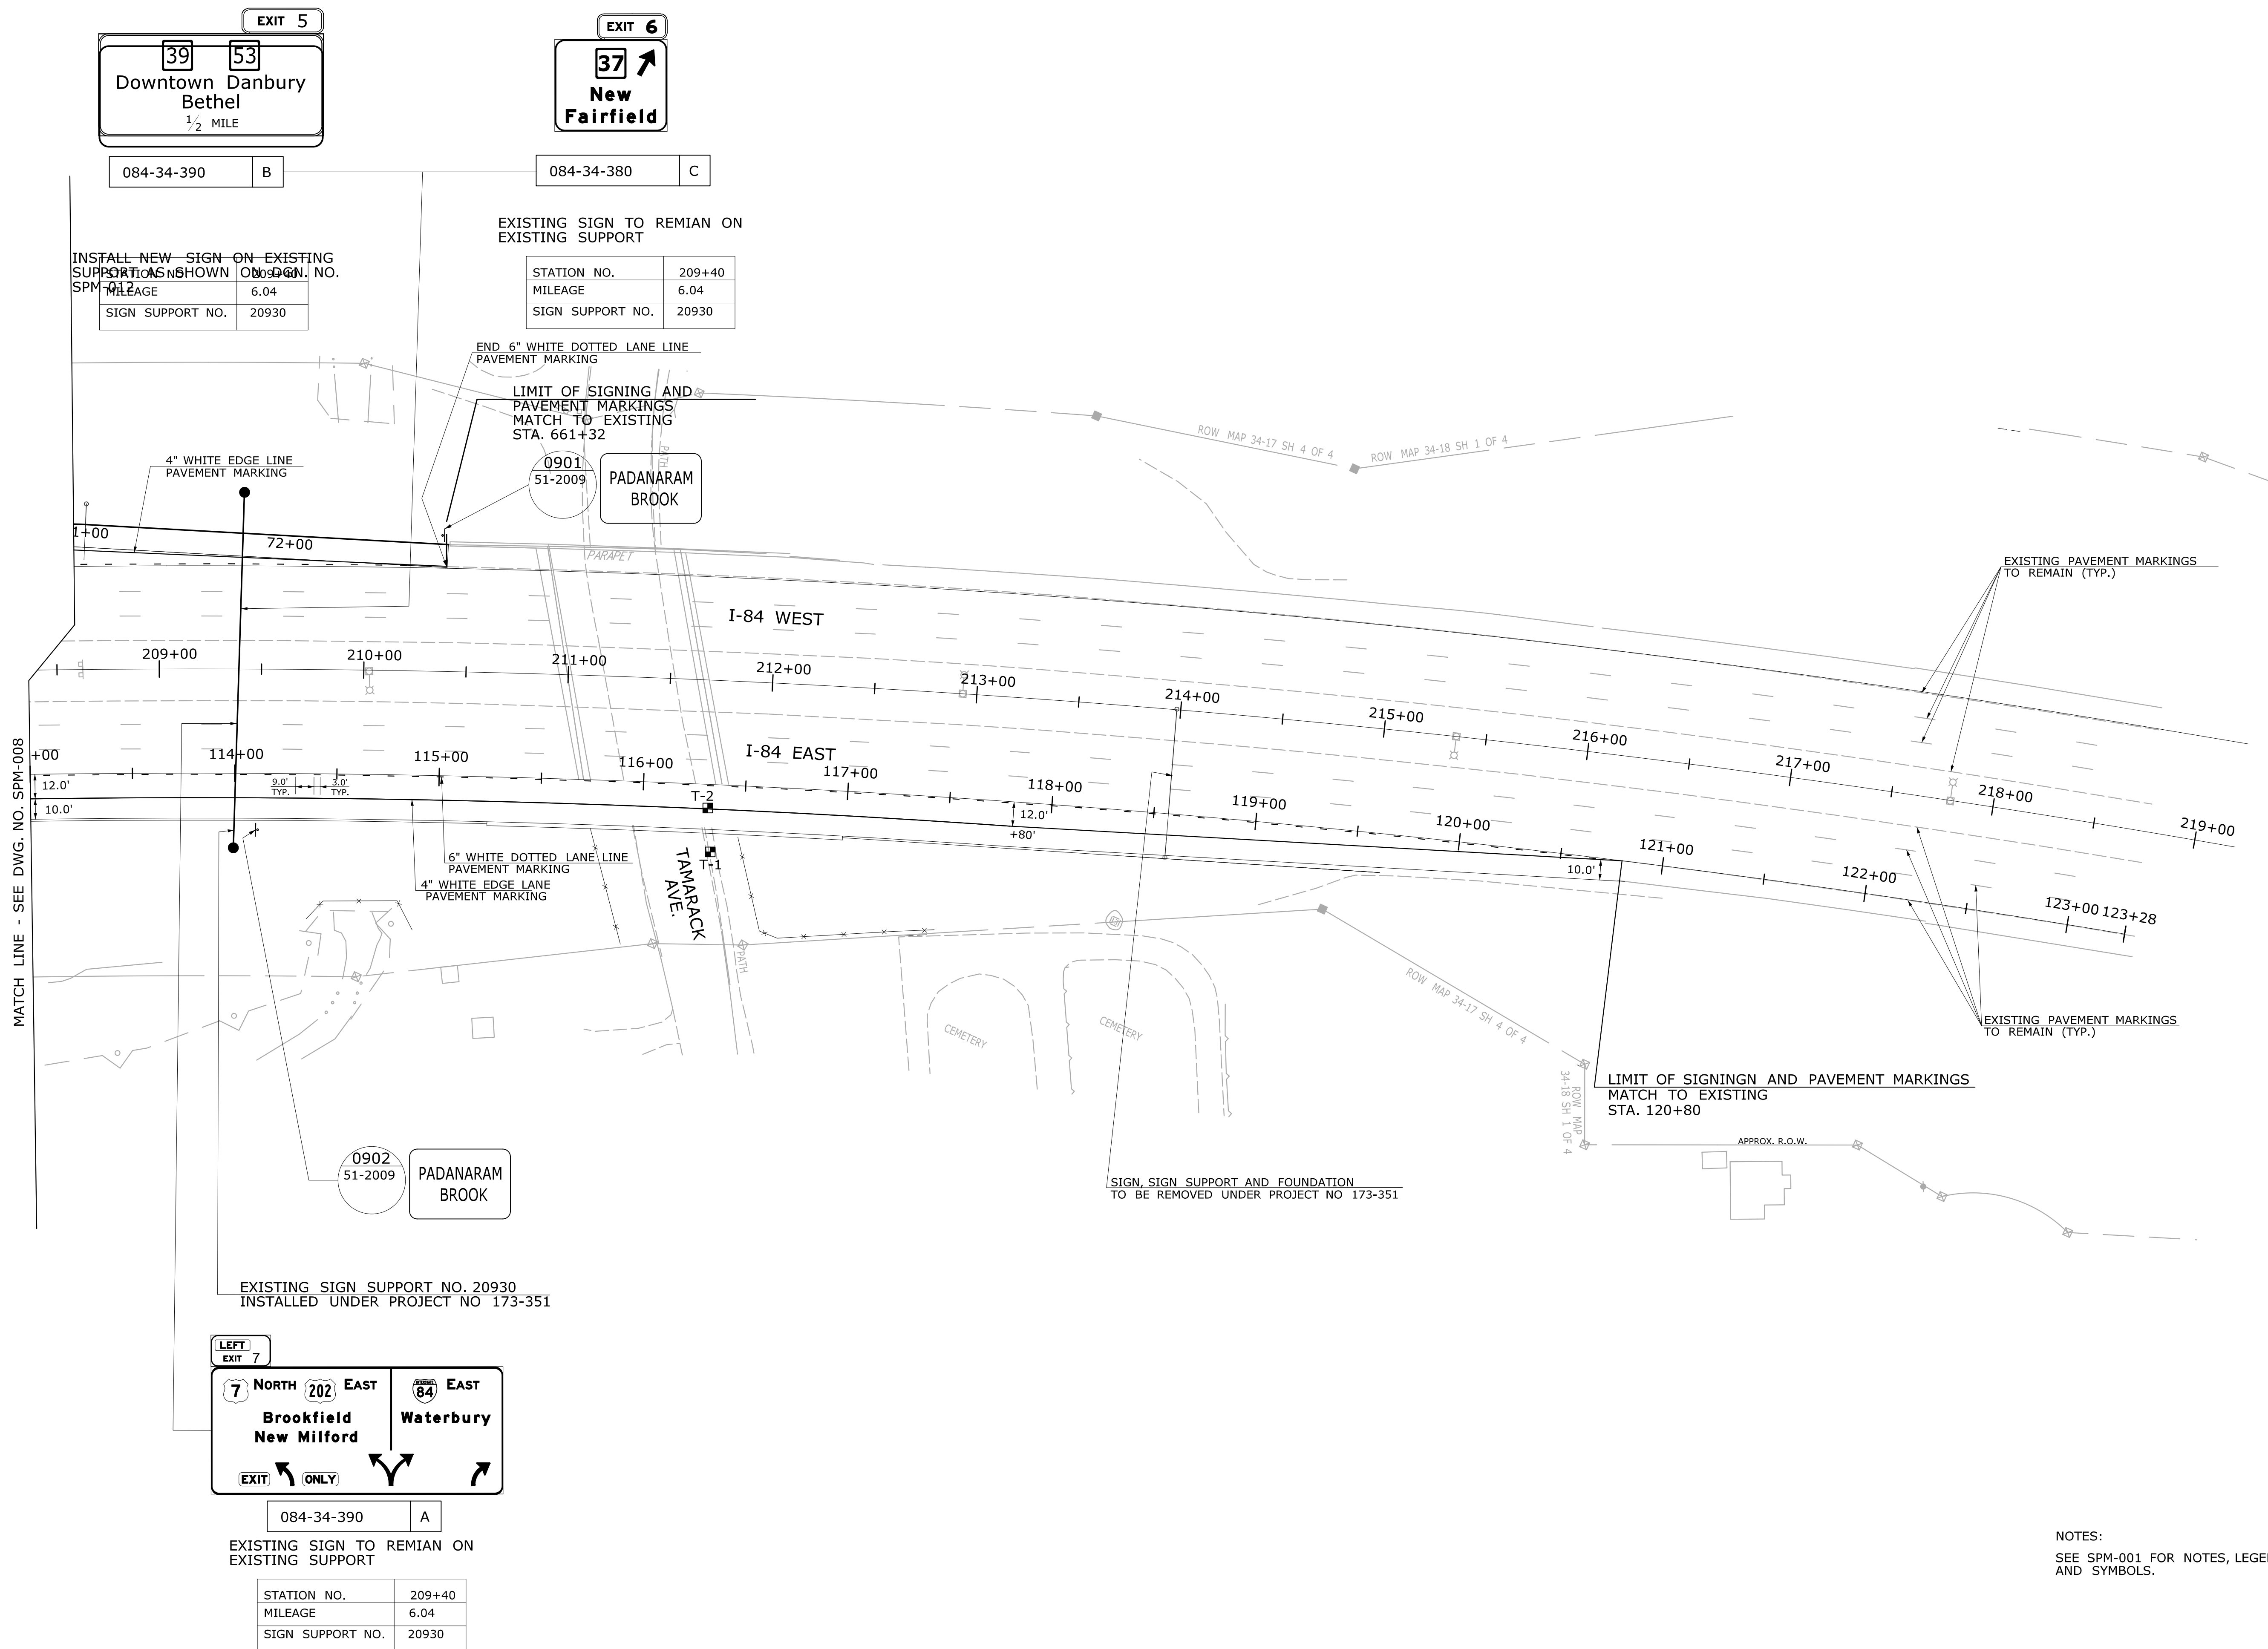

NOTES:
SEE SPM-001 FOR NOTES, LEGEND, STANDARD CONVENTIONS AND SYMBOLS.

ALL DIMENSIONS ARE APPROXIMATE. CONTRACTOR TO VERIFY ALL INFORMATION ON THIS SHEET PRIOR TO ORDERING SIGN SUPPORT STRUCTURES


SEE STRUCTURE SHEETS OCS-1 TO OCS-2 FOR SIGN SUPPORT AND FOUNDATION DETAILS.

BOTTOM OF SIGN TO BE A MIN. OF 18'-0" FROM HIGH POINT OF ROADWAY.

RIGHT EDGE OF EXIT CROWN (FACING ONCOMING TRAFFIC) TO BE ALIGNED WITH RIGHT EDGE OF SIGN AS SHOWN ON THE SIGN DETAIL IN THE SPECIAL PROVISION FOR ITEM NO. 1207034A- SIGN FACE- EXTRUDED ALUMINUM (TYPE IV REFLECTIVE SHEETING).

THE EXISTING SIDE MOUNTED SIGN IS TO BE REMOVED AND RELOCATED TO THE NEW SUPPORT AS SHOWN.



* IF THE HEIGHT OF FOUNDATION IS TO BE GREATER THAN 6" ABOVE THE GROUND LINE, THEN THE 8'-6" MINIMUM DIMENSION IS TO BE MEASURED FROM THE FRONT FACE OF BEAM RAIL TO THE NEAR FACE OF THE FOUNDATION. OTHERWISE IT IS TO BE MEASURED TO THE NEAR FACE OF THE VERTICAL SUPPORT.

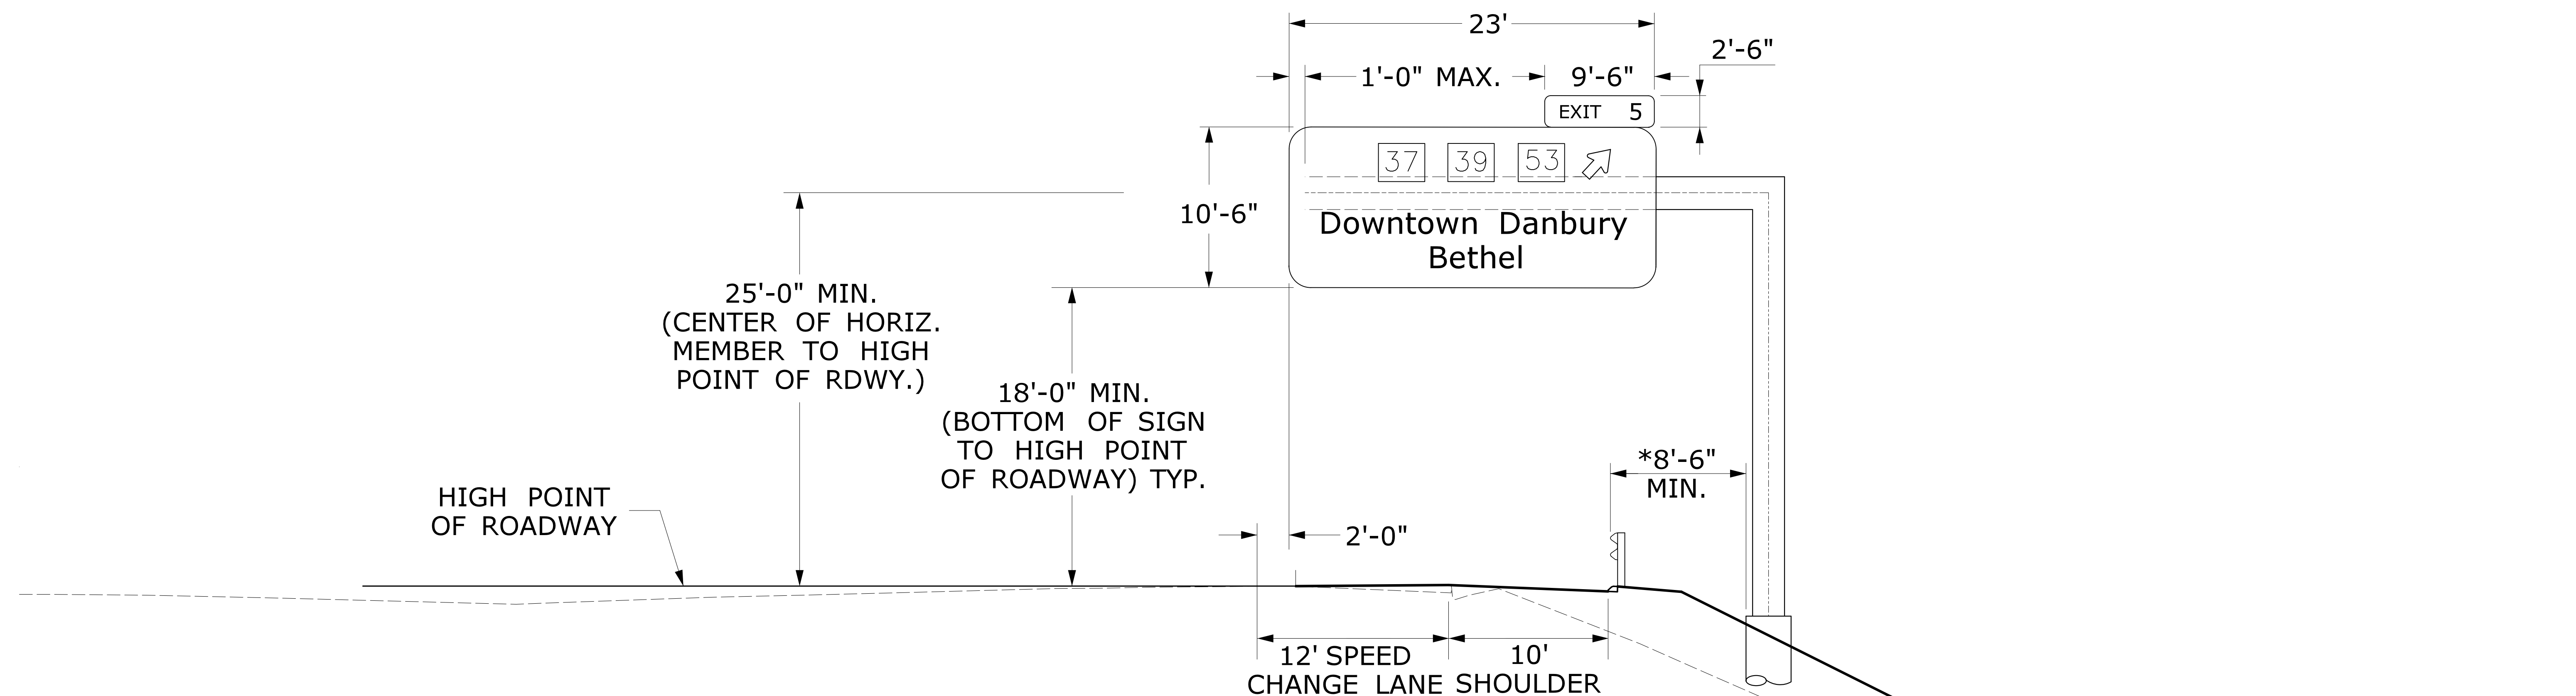

NEW SIGN SUPPORT NO. 22012
SIGN SUPPORT CROSS SECTION
(LOOKING EAST AT FRONT OF SIGN)
SIGN NO. 084-34-340
I-84 E.B. STA. 505+00
PROJECT 34-313

REV. DATE REVISION DESCRIPTION SHEET NO.			THE INFORMATION, INCLUDING ESTIMATED QUANTITIES OF WORK, SHOWN ON THESE SHEETS IS BASED ON LIMITED INVESTIGATIONS BY THE STATE AND IS IN NO WAY WARRANTED TO INDICATE THE CONDITIONS OF ACTUAL QUANTITIES OF WORK WHICH WILL BE REQUIRED.			DESIGNER/DRAFTER: M. BAUER CHECKED BY: M. DION SCALE IN FEET 0 10 20 SCALE 1" = 20'			STATE OF CONNECTICUT DEPARTMENT OF TRANSPORTATION ENGINEER: AECOM USA, Inc. / VN ENGINEERS, Inc. APPROVED BY: SOFIA NIRSHBERG, PE DATE: 03/28/2014			PROJECT TITLE: I-84 INTERCHANGES 5 & 6 IMPROVEMENTS			TOWN: DANBURY DRAWING TITLE: OVERHEAD SIGN CROSS SECTION - 1 (INT 5)			PROJECT NO. 34-313 DRAWING NO. SPM-010 SHEET NO. 06.11		
Filename: TR_MSH_XSC_34-308_1.dgn			3/25/2014			Border Version: 6/1/05														

OVERHEAD SIGN SUPPORT CROSS SECTIONS

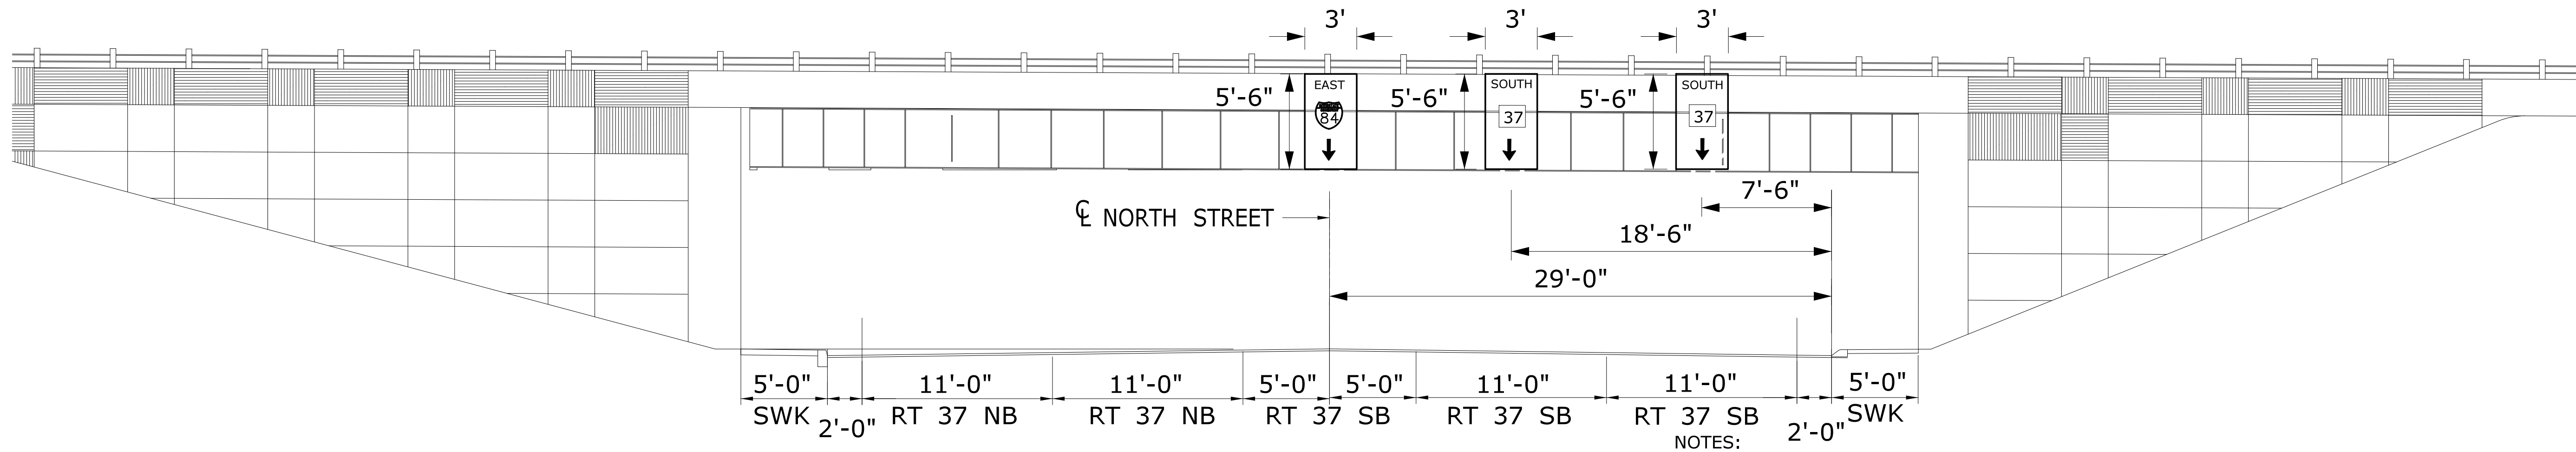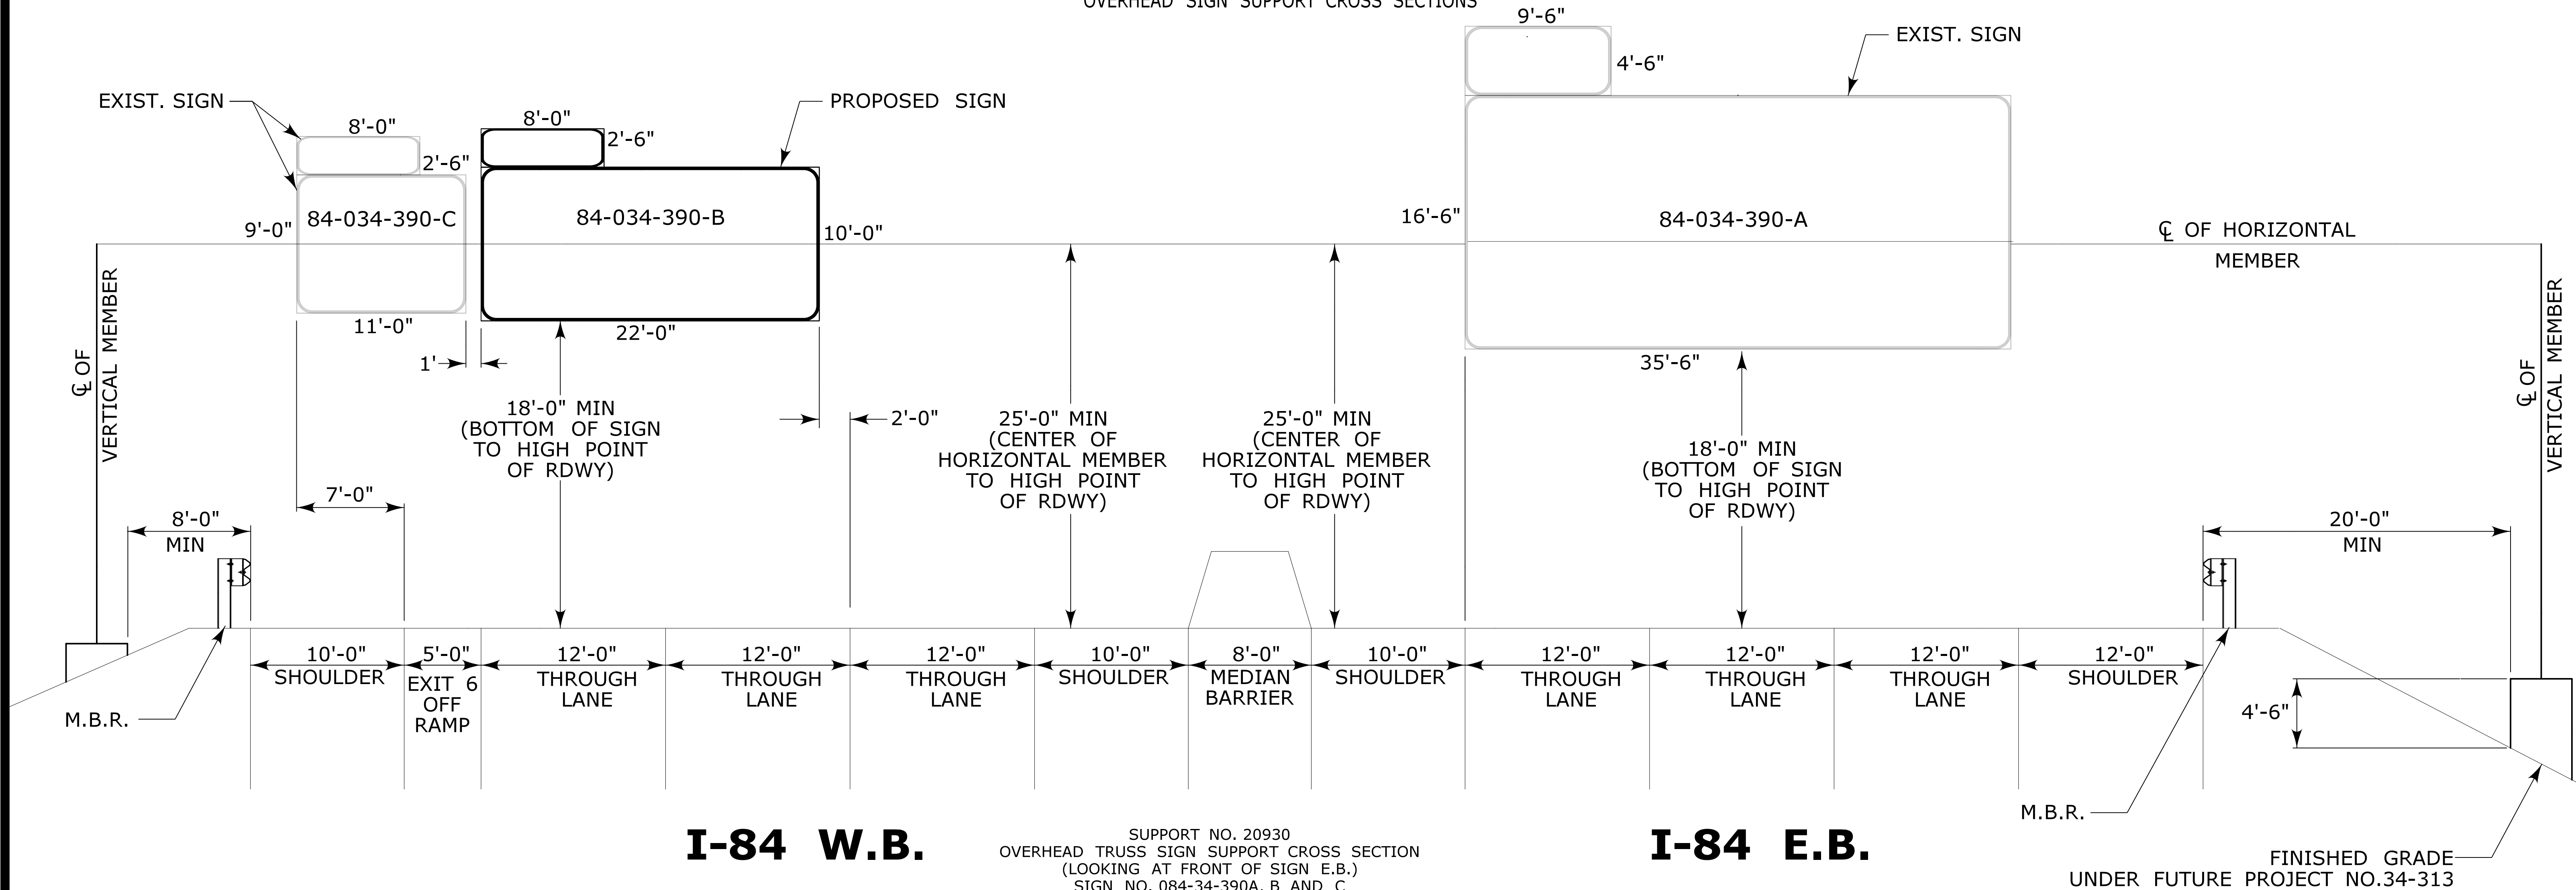

NEW SUPPORT NO'S. 22013A, 22013B & 22013C
ATTACHED TO BRIDGE STRUCTURE
SIGN CROSS SECTION
(LOOKING EAST AT FRONT OF SIGN)
ROUTE 37 STA. 311+52
PROJECT 34-313

THIS SHEET IS USED TO SHOW THE LOCATION OF
SIGN SUPPORT FOUNDATIONS RELATIVE TO THE
EDGE OF ROAD AND THE LOCATION OF SIGNS
RELATIVE TO THE ROADWAY LANES AND CROSS
SLOPE.

ALL INFORMATION ON THIS SHEET IS APPROXIMATE.

THE CONTRACTOR SHALL VERIFY ALL INFORMATION
PRIOR TO ORDERING SIGN SUPPORT STRUCTURES.

BOTTOM OF SIGN TO BE A MIN OF 18'-0" FROM HIGH
POINT OF ROADWAY.

RIGHT EDGE OF EXIT CROWN (FACING ONCOMING
TRAFFIC) TO BE ALIGNED WITH RIGHT EDGE OF SIGN
AS SHOWN.

SEE STRUCTURE SHEETS SMSS-001 AND SMSS-002 FOR
BRIDGE MOUNTED SIGN SUPPORT AND MOUNTING DETAILS.

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R1-1 * <div></div> <div>LEGEND - WHITE BACKGROUND - RED</div> <table><thead><tr><th>AREA (SQ. FT)</th><th>SIZE (INCHES)</th><th>CONN. D.O.T. #</th><th>POSTS</th><th>ALUM. THK.</th></tr></thead><tbody><tr><td>3.31</td><td>24</td><td>31-0536</td><td>1</td><td>.080</td></tr><tr><td>5.19</td><td>30</td><td>31-0552</td><td>1</td><td>.080</td></tr><tr><td>7.98</td><td>36</td><td>31-0553</td><td>1</td><td>.080</td></tr><tr><td>13.3</td><td>48</td><td>31-0557</td><td>2</td><td>.100</td></tr></tbody></table>										AREA (SQ. FT)	SIZE (INCHES)	CONN. D.O.T. #	POSTS	ALUM. THK.	3.31	24	31-0536	1	.080	5.19	30	31-0552	1	.080	7.98	36	31-0553	1	.080	13.3	48	31-0557	2	.100	R2-1 <div></div> <div>LEGEND - BLACK BACKGROUND - WHITE</div> <table><thead><tr><th>AREA (SQ. FT)</th><th>SIZE (INCHES)</th><th>CONN. D.O.T. #</th><th>POSTS</th><th>ALUM. THK.</th></tr></thead><tbody><tr><td>5.00</td><td>24X30</td><td>31-5505</td><td>1</td><td>.080</td></tr><tr><td>7.50</td><td>30X36</td><td>31-5504</td><td>1</td><td>.080</td></tr><tr><td>12.00</td><td>36X48</td><td>31-5506</td><td>2</td><td>.100</td></tr><tr><td>20.00</td><td>48X60</td><td>31-5507</td><td>2</td><td>.100</td></tr></tbody></table>										AREA (SQ. FT)	SIZE (INCHES)	CONN. D.O.T. #	POSTS	ALUM. THK.	5.00	24X30	31-5505	1	.080	7.50	30X36	31-5504	1	.080	12.00	36X48	31-5506	2	.100	20.00	48X60	31-5507	2	.100	R3-1 <div></div> <div>31-1604 OVERHEAD MTD</div> <div>LEGEND - BLACK BACKGROUND - WHITE</div> <table><thead><tr><th>AREA (SQ. FT)</th><th>SIZE (INCHES)</th><th>CONN. D.O.T. #</th><th>POSTS</th><th>ALUM. THK.</th></tr></thead><tbody><tr><td>4.00</td><td>24X24</td><td>31-1604</td><td>1</td><td>.080</td></tr><tr><td>6.25</td><td>30X30</td><td>31-1617</td><td>1</td><td>.080</td></tr><tr><td>5.00</td><td>30X24</td><td>31-1618</td><td>1</td><td>.080</td></tr><tr><td>9.00</td><td>36X36</td><td>31-1627</td><td>2</td><td>.080</td></tr><tr><td>7.50</td><td>36X30</td><td>31-1628</td><td>1</td><td>.080</td></tr></tbody></table>										AREA (SQ. FT)	SIZE (INCHES)	CONN. D.O.T. #	POSTS	ALUM. THK.	4.00	24X24	31-1604	1	.080	6.25	30X30	31-1617	1	.080	5.00	30X24	31-1618	1	.080	9.00	36X36	31-1627	2	.080	7.50	36X30	31-1628	1	.080	R3-5 <div><div></div><div>(L)</div><div></div><div>(R)</div><div></div><div>ONLY</div><div></div><div>31-0282</div><div></div><div>31-0283</div><div></div><div>31-0282b</div><div><div>LEFT LANE MUST TURN LEFT</div><div>RIGHT LANE MUST TURN RIGHT</div></div></div>										R3-8b <div><div></div><div>31-0282b</div><div><div>LEFT LANE MUST TURN LEFT</div><div>RIGHT LANE MUST TURN RIGHT</div></div></div>										R4-1 <div><div></div><div>DO NOT PASS</div></div> <div><div></div><div>KEEP RIGHT EXCEPT TO PASS</div></div>					R5-1 * <div></div> <div>DO NOT ENTER</div> <div></div> <div>PROHIBITED PEDESTRIANS MOTOR BIKES MOTOR SCOOTERS BICYCLES</div>				
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AREA (SQ. FT)	SIZE (INCHES)	CONN. D.O.T. #	POSTS	ALUM. THK.																																																																																																																																							
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9.00	36X36	31-1629	2	.080																																																																																																																																							
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R1-3 * <div></div> <div>LEGEND - WHITE BACKGROUND - RED</div> <table><thead><tr><th>AREA (SQ. FT)</th><th>SIZE (INCHES)</th><th>CONN. D.O.T. #</th><th>POSTS</th><th>ALUM. THK.</th></tr></thead><tbody><tr><td>0.75</td><td>18X6</td><td>31-0508</td><td></td><td>.080</td></tr><tr><td></td><td></td><td></td><td></td><td></td></tr><tr><td></td><td></td><td></td><td></td><td></td></tr><tr><td></td><td></td><td></td><td></td><td></td></tr></tbody></table>										AREA (SQ. FT)	SIZE (INCHES)	CONN. D.O.T. #	POSTS	ALUM. THK.	0.75	18X6	31-0508		.080																R2-4b <div></div> <div>LEGEND - WHITE BACKGROUND - RED</div> <table><thead><tr><th>AREA (SQ. FT)</th><th>SIZE (INCHES)</th><th>CONN. D.O.T. #</th><th>POSTS</th><th>ALUM. 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THK.	0.75	18X6	31-0508		.080																R3-3 <div></div> <div>NO TURNS</div> <div><div></div><div>LEFT LANE MUST TURN LEFT</div><div></div><div>RIGHT LANE MUST TURN RIGHT</div><div></div><div>31-0222</div><div></div><div>31-0223</div><div></div><div>31-0370</div><div></div><div>31-0371</div><div></div><div>31-0372</div><div></div><div>31-0373</div><div></div><div>31-0374</div><div></div><div>31-0375</div><div></div><div>31-0376</div><div></div><div>31-0377</div><div></div><div>31-0378</div><div></div><div>31-0379</div><div></div><div>31-0380</div><div></div><div>31-0381</div><div></div><div>31-0382</div><div></div><div>31-0383</div><div></div><div>31-0384</div><div></div><div>31-0385</div><div></div><div>31-0386</div><div></div><div>31-0387</div><div></div><div>31-0388</div><div></div><div>31-0389</div><div></div><div>31-0390</div><div></div><div>31-0391</div><div></div><div>31-0392</div><div></div><div>31-0393</div><div></div><div>31-0394</div><div></div><div>31-0395</div><div></div><div>31-0396</div><div></div><div>31-0397</div><div></div><div>31-0398</div><div></div><div>31-0399</div><div></div><div>31-0400</div><div></div><div>31-0401</div><div></div><div>31-0402</div><div></div><div>31-0403</div><div></div><div>31-0404</div><div></div><div>31-0405</div><div></div><div>31-0406</div><div></div><div>31-0407</div><div></div><div>31-0408</div><div></div><div>31-0409</div><div></div><div>31-0410</div><div></div><div>31-0411</div><div></div><div>31-0412</div><div></div><div>31-0413</div><div></div><div>31-0414</div><div></div><div>31-0415</div><div></div><div>31-0416</div><div></div><div>31-0417</div><div></div><div>31-0418</div><div></div><div>31-0419</div><div></div><div>31-0420</div><div></div><div>31-0421</div><div></div><div>31-0422</div><div></div><div>31-0423</div><div></div><div>31-0424</div><div></div><div>31-0425</div><div></div><div>31-0426</div><div></div><div>31-0427</div><div></div><div>31-0428</div><div></div><div>31-0429</div><div></div><div>31-0430</div><div></div><div>31-0431</div><div></div><div>31-0432</div><div></div><div>31-0433</div><div></div><div>31-0434</div><div></div><div>31-0435</div><div></div><div>31-0436</div><div></div><div>31-0437</div><div></div><div>31-0438</div><div></div><div>31-0439</div><div></div><div>31-0440</div><div></div><div>31-0441</div><div></div><div>31-0442</div><div></div><div>31-0443</div><div></div><div>31-0444</div><div></div><div>31-0445</div><div></div><div>31-0446</div><div></div><div>31-0447</div><div></div><div>31-0448</div><div></div><div>31-0449</div><div></div><div>31-0450</div><div></div><div>31-0451</div><div></div><div>31-0452</div><div></div><div>31-0453</div><div></div><div>31-0454</div><div></div><div>31-0455</div><div></div><div>31-0456</div><div></div><div>31-0457</div><div></div><div>31-0458</div><div></div><div>31-0459</div><div></div><div>31-0460</div><div></div><div>31-0461</div><div></div><div>31-0462</div><div></div><div>31-0463</div><div></div><div>31-0464</div><div></div><div>31-0465</div><div></div><div>31-0466</div><div></div><div>31-0467</div><div></div><div>31-0468</div><div></div><div>31-0469</div><div></div><div>31-0470</div><div></div><div>31-0471</div><div></div><div>31-0472</div><div></div><div>31-0473</div><div></div><div>31-0474</div><div></div><div>31-0475</div><div></div><div>31-0476</div><div></div><div>31-0477</div><div></div><div>31-0478</div><div></div><div>31-0479</div><div></div><div>31-0480</div><div></div><div>31-0481</div><div></div><div>31-0482</div><div></div><div>31-0483</div><div></div><div>31-0484</div><div></div><div>31-0485</div><div></div><div>31-0486</div><div></div><div>31-0487</div><div></div><div>31-0488</div><div></div><div>31-0489</div><div></div><div>31-0490</div><div></div><div>31-0491</div><div></div><div>31-0492</div><div></div><div>31-0493</div><div></div><div>31-0494</div><div></div><div>31-0495</div><div></div><div>31-0496</div><div></div><div>31-0497</div><div></div><div>31-0498</div><div></div><div>31-0499</div><div></div><div>31-0500</div><div></div><div>31-0501</div><div></div><div>31-0502</div><div></div><div>31-0503</div><div></div><div>31-0504</div><div></div><div>31-0505</div><div></div><div>31-0506</div><div></div><div>31-0507</div><div></div><div>31-0508</div><div></div><div>31-0509</div><div></div><div>31-0510</div><div></div><div>31-0511</div><div></div><div>31-0512</div><div></div><div>31-0513</div><div></div><div>31-0514</div><div></div><div>31-0515</div><div></div><div>31-0516</div><div></div><div>31-0517</div><div></div><div>31-0518</div><div></div><div>31-0519</div><div></div><div>31-0520</div><div></div><div>31-0521</div><div></div><div>31-0522</div></div>																																																																					
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R6-1 <div><div></div><div>(L)</div><div></div><div>(R)</div></div>										R7-1 <div><div></div><div>HANDICAPPED PARKING PERMIT REQUIRED VIOLATORS WILL BE FINED MIN \$150</div></div>										R8-7 <div></div> <div>EMERGENCY STOPPING ONLY</div>										R9-1 <div></div> <div>HITCHHIKING PROHIBITED DO NOT STOP</div>										R10-6 <div><div></div><div>STOP HERE ON RED</div><div></div><div>STOP HERE ON RED</div><div>31-0801</div><div>31-0802</div><div>OVERHEAD MOUNTED</div><div></div><div>NO TURN ON RED</div><div></div><div>RIGHT TURN ON RED FROM RIGHT LANE ONLY</div></div>										R11-1 <div></div> <div>KEEP OFF MEDIAN</div>																																																																																									
AREA (SQ. FT)SIZE (INCHES)CONN. D.O.T. #POSTSALUM. THK. 3.0036X1231-1188L1.080 3.0036X1231-1188R1.080										AREA (SQ. FT)SIZE (INCHES)CONN. D.O.T. #POSTSALUM. THK. 12.0036X4831-06672.080										AREA (SQ. FT)SIZE (INCHES)CONN. D.O.T. #POSTSALUM. THK. 12.0036X4831-06672.080										AREA (SQ. FT)SIZE (INCHES)CONN. D.O.T. #POSTSALUM. THK. 12.0036X4831-06672.080										AREA (SQ. FT)SIZE (INCHES)CONN. D.O.T. #POSTSALUM. THK. 12.0036X4831-06672.080										AREA (SQ. FT)SIZE (INCHES)CONN. D.O.T. #POSTSALUM. THK. 12.0036X4831-06672.080																																																																																									



REV.	DATE	REVISION DESCRIPTION	SHEET NO.
Filename	2012-11-20	CTDOT TRAFFIC GD.dgn	3/25/2014
			Border Version

CONSTRUCTION NOTES AND SPECIFICATIONS


EMERGENCY PRE-EMPTION NOTES

CONTRACTOR TO INSTALL A SWITCH IN THE SIGNAL CABINET TO EFFECTIVELY DISCONNECT THE PRE-EMPTION EQUIPMENT FROM THE TRAFFIC SIGNAL CONTROLLER.

PRE-EMPTION DETECTOR LOCATIONS ARE FOR ILLUSTRATION ONLY.
EXACT LOCATIONS SHALL BE DETERMINED BY THE MANUFACTURER OR
HIS DESIGNATED REPRESENTATIVE. DETECTOR CABLES ARE TO BE
INSTALLED CONTINUOUS BETWEEN EACH DETECTOR AND THE
AUXILIARY EQUIPMENT CABINET.

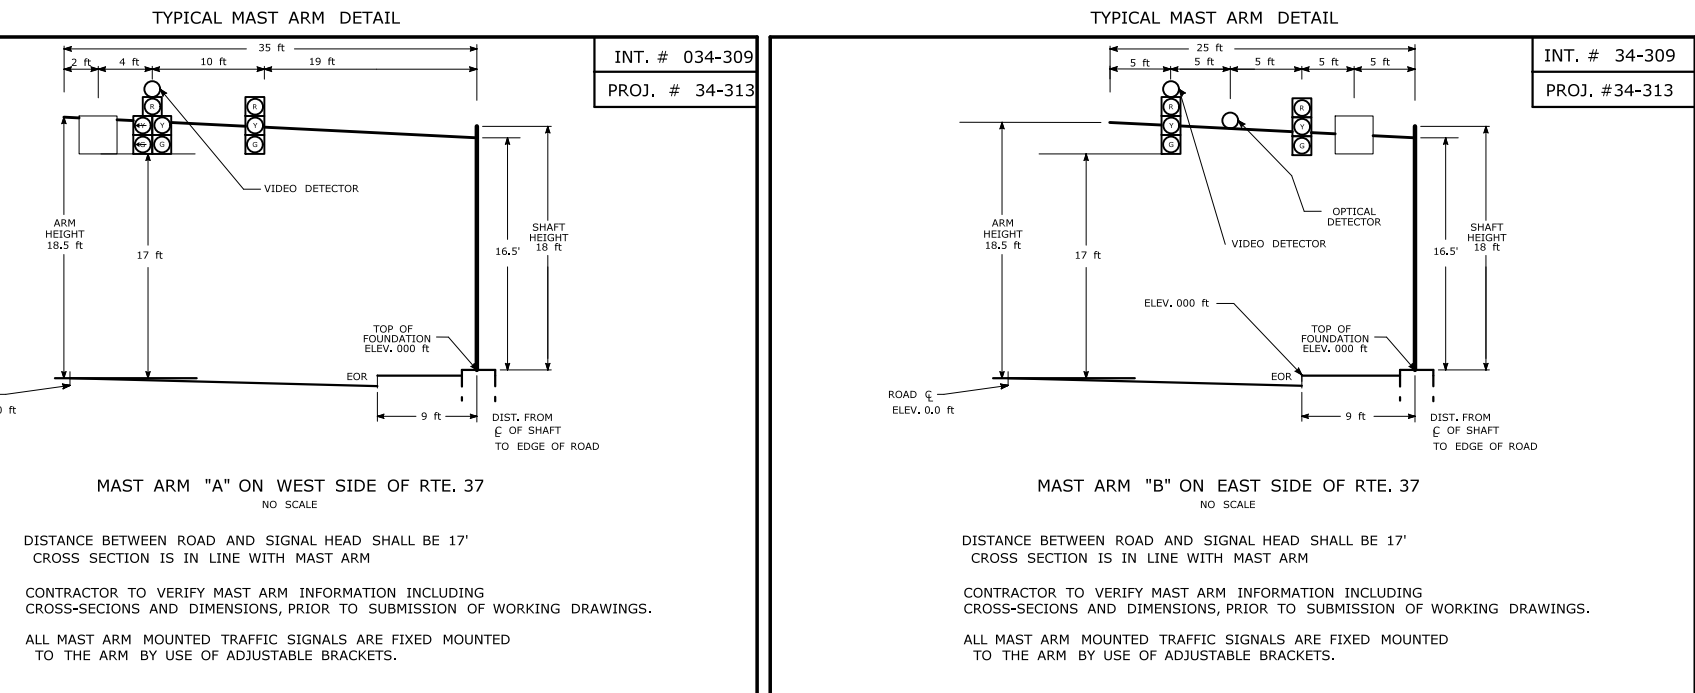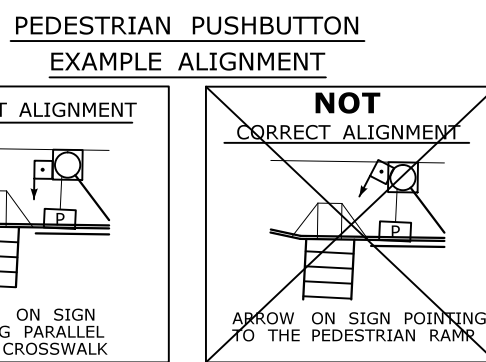

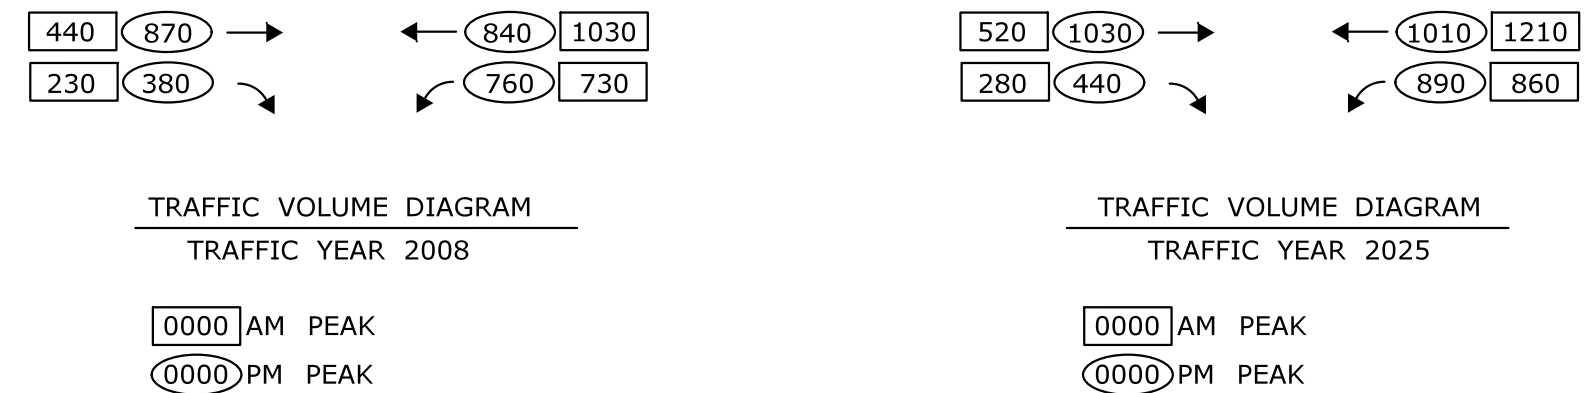

SIGNAL	HOOK-UP	CHART	34-309
HEAD #	COLORS	PHASE	TERMINALS
2	R,Y,G	2	128,129,130
5	YA, GA	5	132,133
5	R,Y,G	2	128,129,130
6	R, Y, G	6	134,135,136
P	DW, W	P	119,121




CITY SIGNAL

STATE OF CONNECTICUT
DEPARTMENT OF TRANSPORTATION



				 	TOWN: DANBURY		PROJECT NO.: 34 313
NO.	DATE	INIT.	DESCRIPTION		DRAWING TITLE:	DRAWING NO.: TCS-001	SHEET NO.: 06.16
REVISIONS							

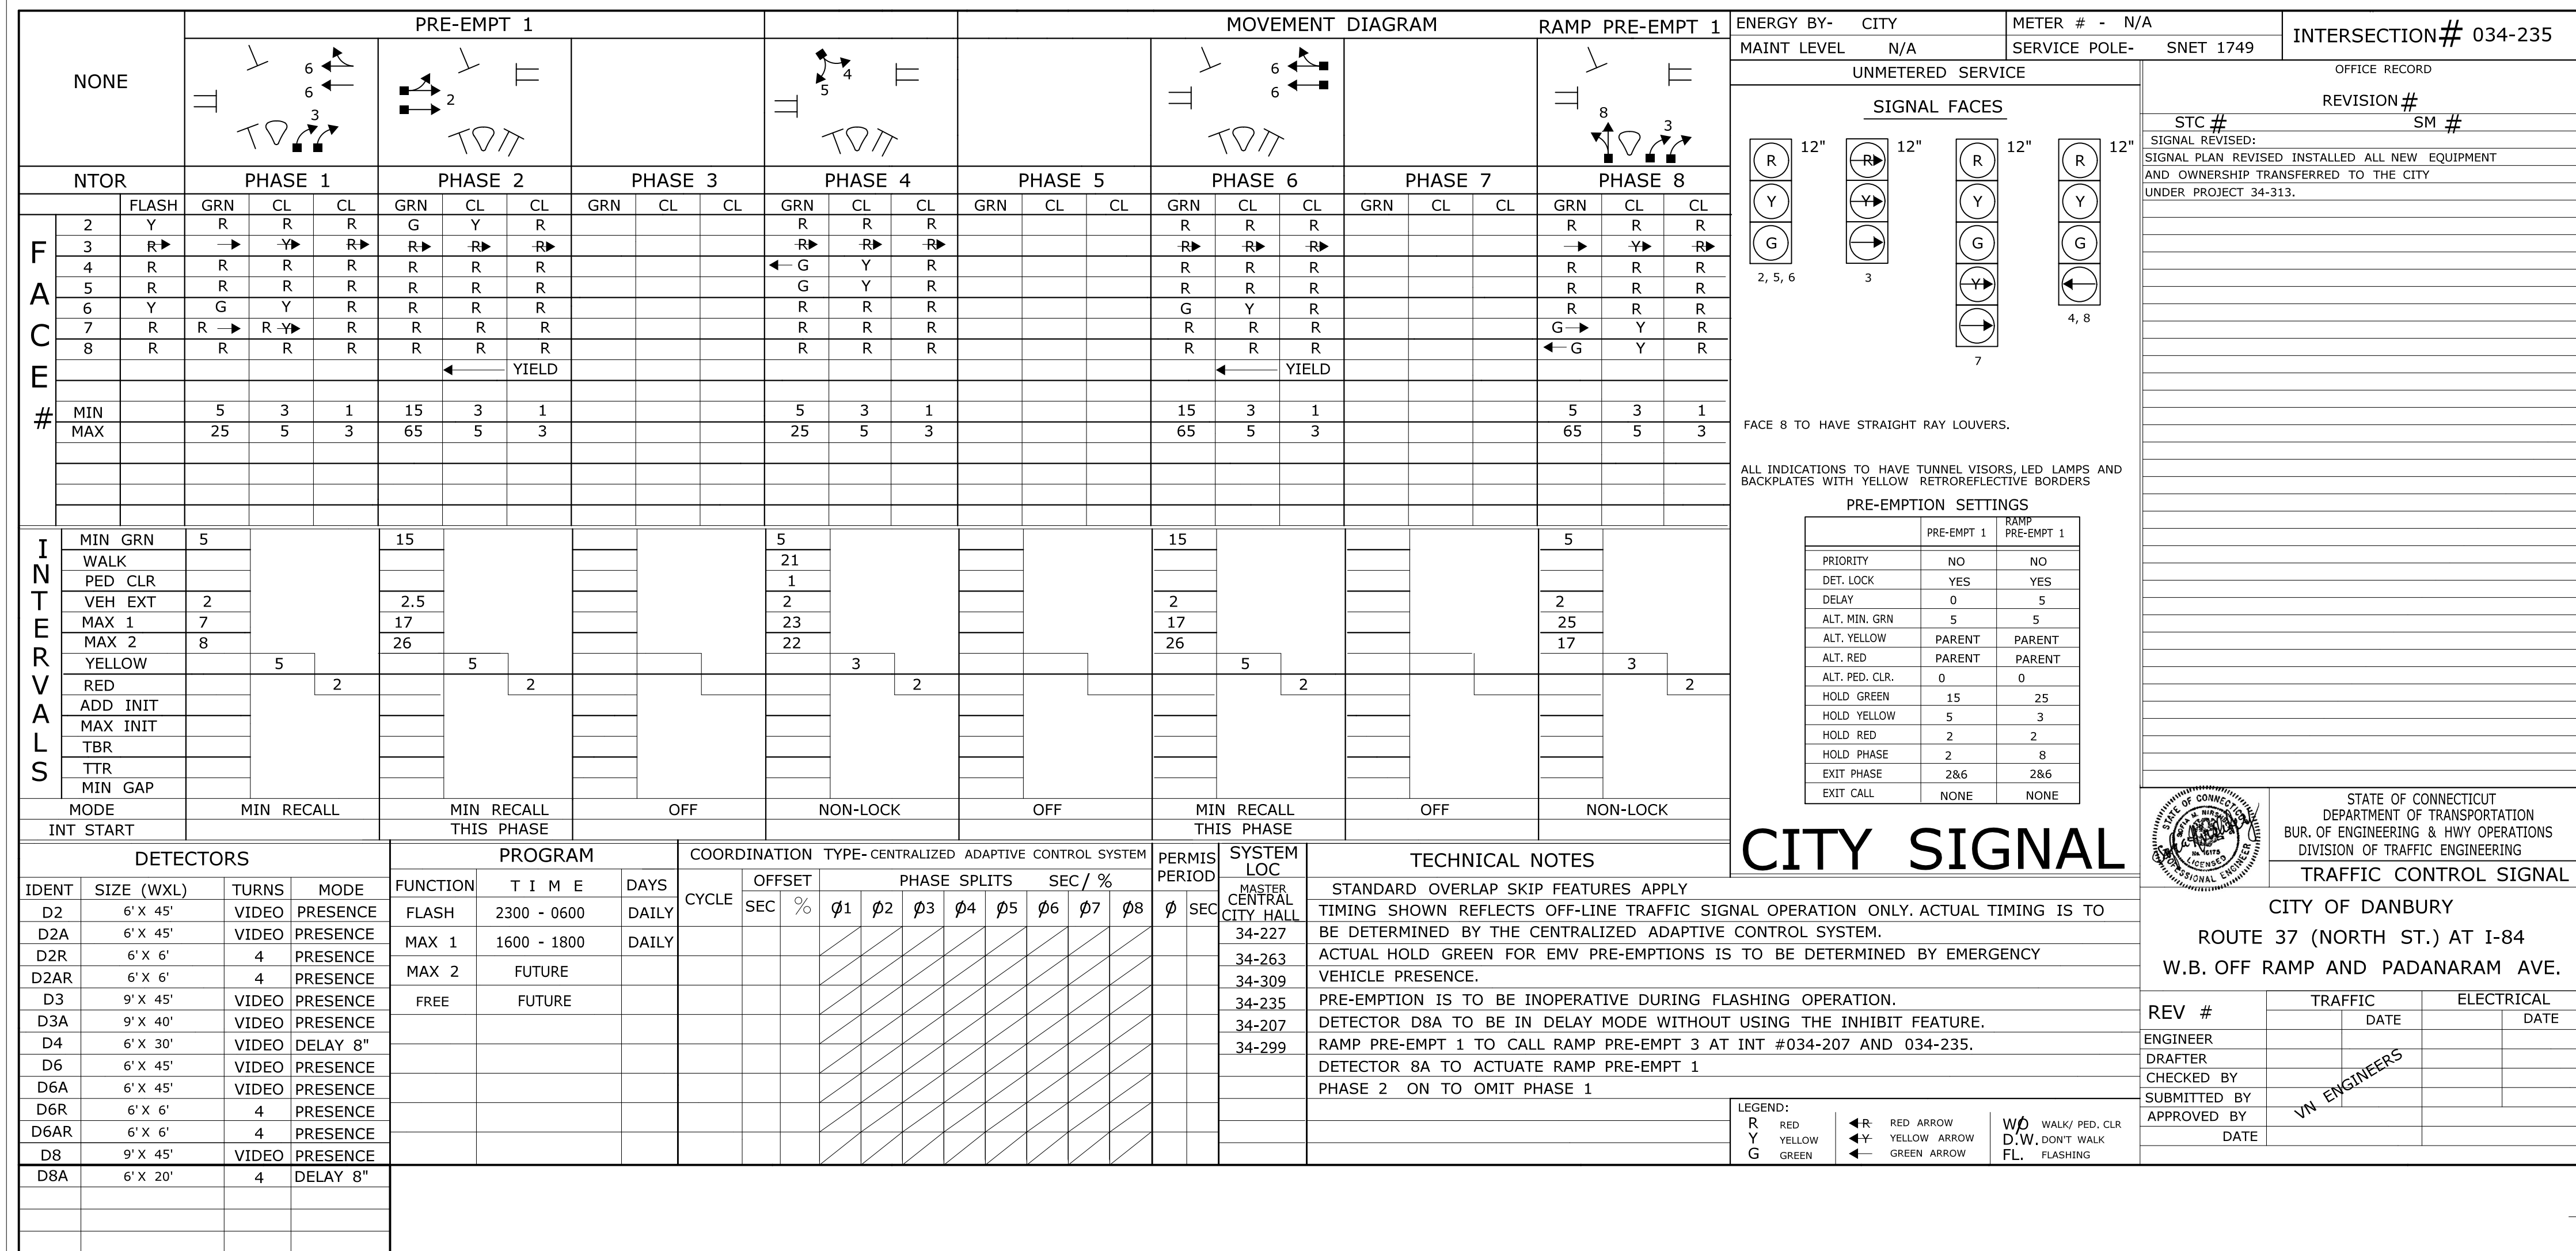

CONSTRUCTION NOTES AND SPECIFICATIONS

ALL TRAFFIC EQUIPMENT SHALL BE NEW.

CONTRACTOR SHALL STAKE ALL R.O.W. PRIOR TO EXCAVATION

CONTRACTOR SHALL CONTACT "CALL BEFORE YOU DIG" PRIOR TO EXCAVATION

CONTRACTOR IS TO CONTACT ALL PUBLIC AND PRIVATE UTILITY COMPANIES PRIOR TO START OF CONSTRUCTION TO INFORM AND RESOLVE ALL RELATIVE ISSUES.

ALL EQUIPMENT INCLUDING SIGNAL HEADS, SPAN POLES, AND CABINET SHALL BE DARK GREEN, NO. 14056, FEDERAL NO. 595.

ALL INTERSECTIONS ARE TO BE HARDWARE INTERCONNECTED UTILIZING CORNING
TWELVE (12) STRANDS SINGLE MODE, ALTOS GEL-FREE, FIBER OPTIC CABLE.

ALL COPPER AND OPTICAL CABLES ARE TO BE CONTINUOUS WITHOUT SPLICES
UNLESS NOTED OTHERWISE.

SIGNAL APPURTENANCES (MAST ARMS, PEDESTALS, AND HAND HOLES) WHEN IN OR ADJACENT TO SIDEWALKS SHALL BE FIELD LOCATED TO PROVIDE A FREE PATH OF NOT LESS THAN 4.0 FEET. ANY PROPOSED REVISIONS TO THE LOCATIONS OF THE APPURTENANCES SHOWN ON THE PLANS MUST BE SUBMITTED FOR REVIEW AND APPROVAL BY THE DIVISION OF TRAFFIC ENGINEERING AND THE CITY OF DANBURY.

- (U) INSTALL CAMERA VIDEO DETECTION ON 16' CAMERA ARM.
- (M) SPAN POLE REQUIRES 2 SPAN CLAMPS.
- (W) INSTALL 30" X 30" HANDHOLE. ALL OTHERS TYPE II.


ALL HANDHOLES INSTALLED WITHIN SIDEWALK SHALL HAVE CAST IRON COVERS

ALL INDUCTIVE LOOP DETECTORS ARE TO BE PREFORMED WITH 4 TURNS TYPE



EMERGENCY PRE-EMPTION NOTES



CONTRACTOR TO INSTALL A SWITCH IN THE SIGNAL CABINET TO EFFECTIVELY DISCONNECT THE PRE-EMPTION EQUIPMENT FROM THE TRAFFIC SIGNAL CONTROLLER.

PRE-EMPTION DETECTOR LOCATIONS ARE FOR ILLUSTRATION ONLY.
EXACT LOCATIONS SHALL BE DETERMINED BY THE MANUFACTURER OR
HIS DESIGNATED REPRESENTATIVE. DETECTOR CABLES ARE TO BE
INSTALLED CONTINUOUS BETWEEN EACH DETECTOR AND THE
AUXILIARY EQUIPMENT CABINET.

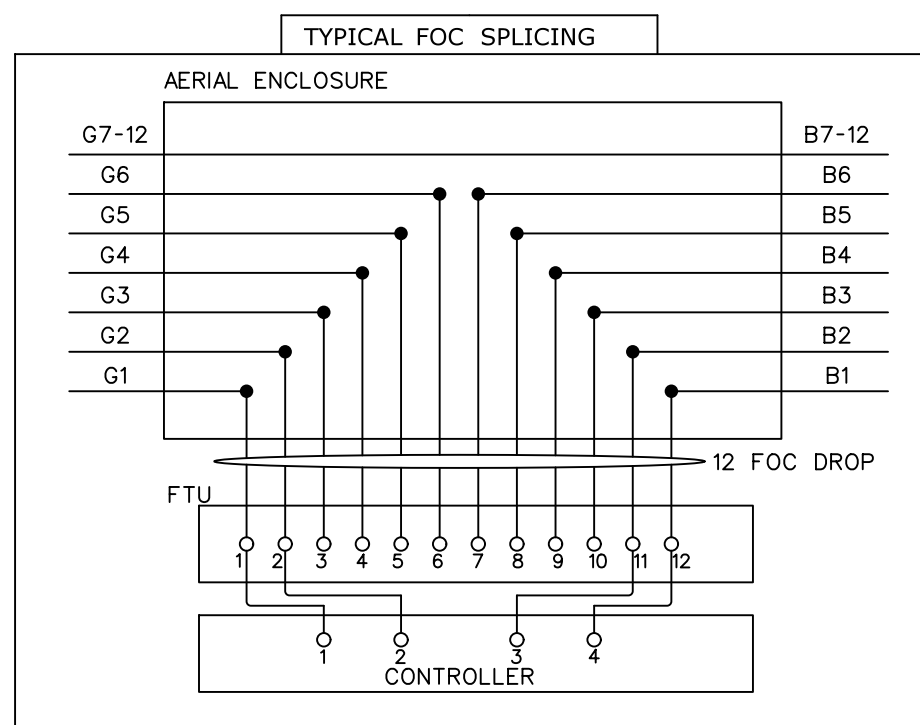

FIBER OPTIC CABLE COLOR CODE		TYPICAL FIBER OPTIC CABLE SPLICE CHART			
CABLE FROM/TO	COLOR	FROM/TO		FROM/TO	
INT NO. 34-309	GREEN	FOC COLOR	FOC STRAND	FOC COLOR	FOC STRAND
INT NO. 34-207	BLUE	GREEN	1-6	RED	1-6
CONTROLLER	RED	BLUE	1-6	RED	7-12
NOTE: GREEN/BLUE 7-12 TO PASS THRU WITHOUT SPLICING					

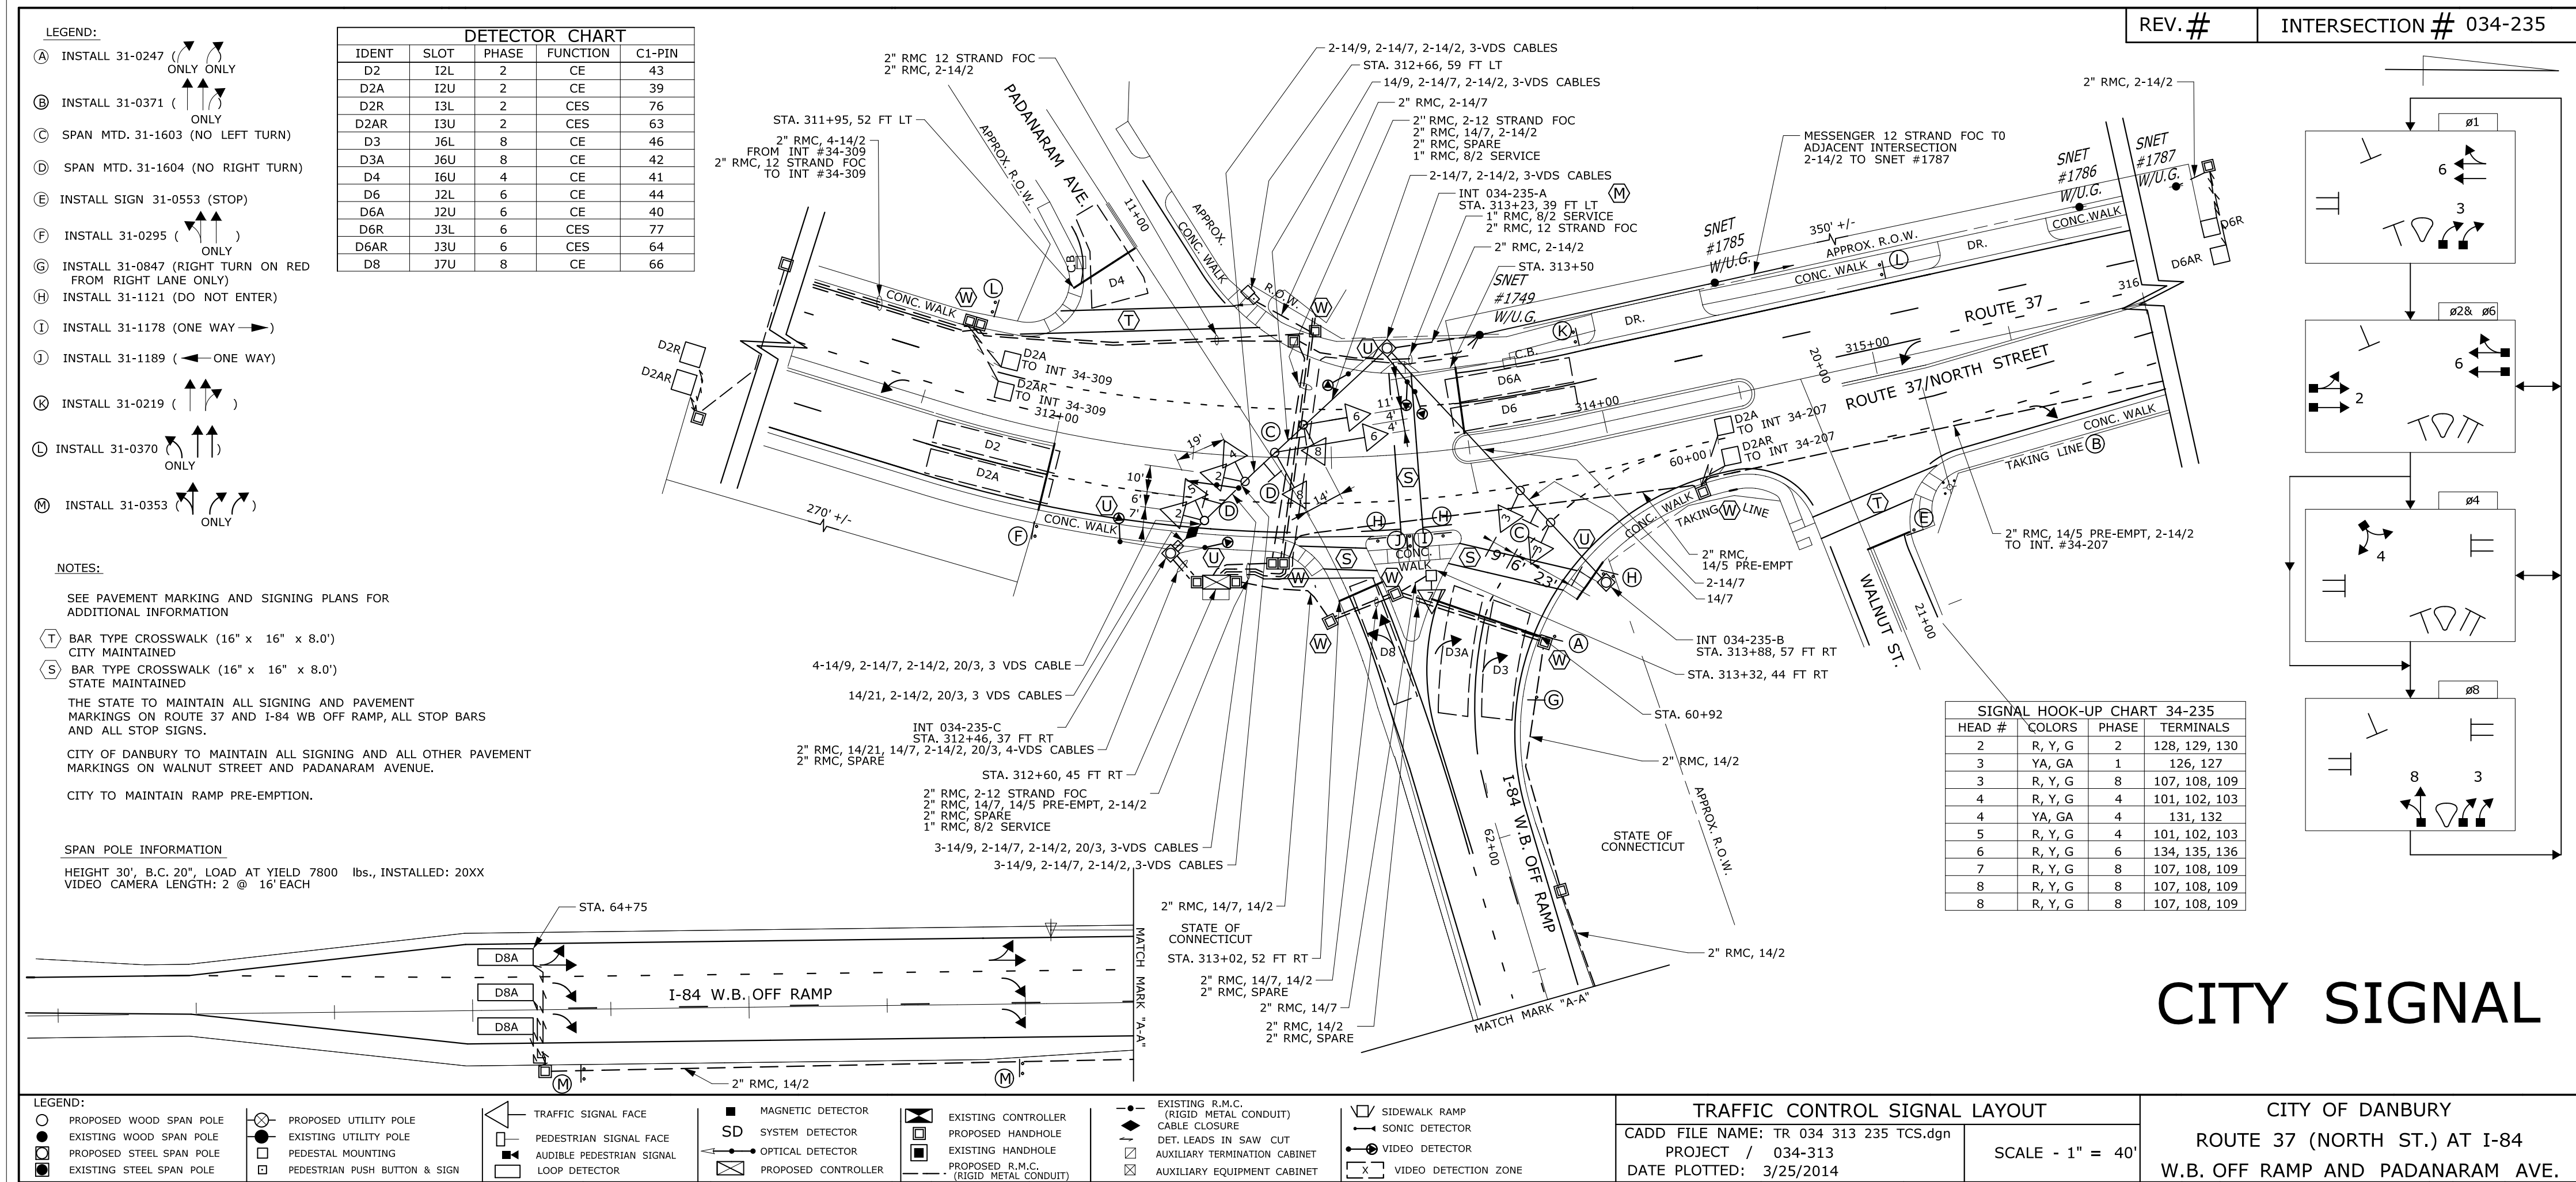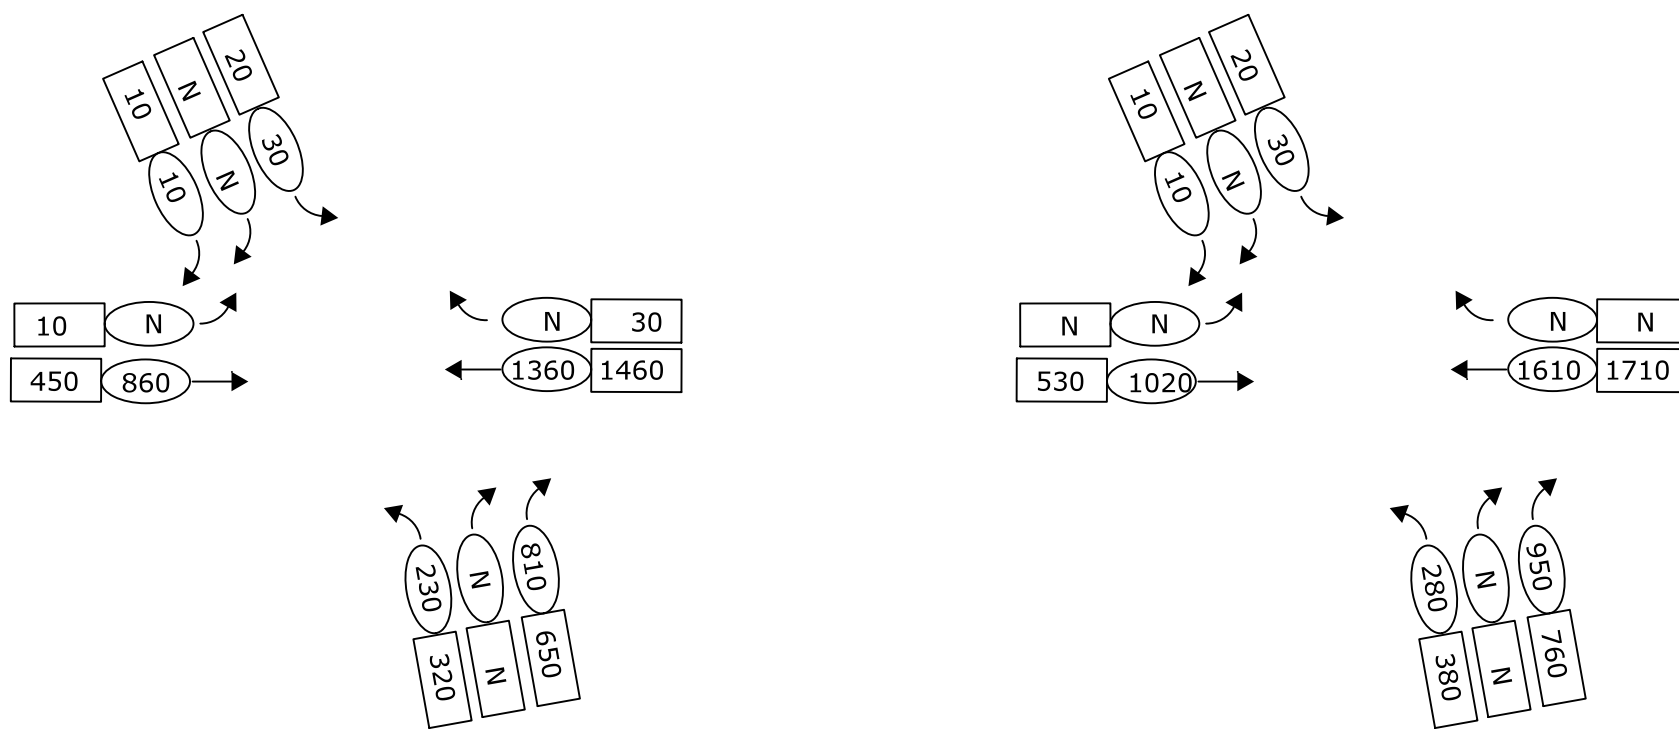

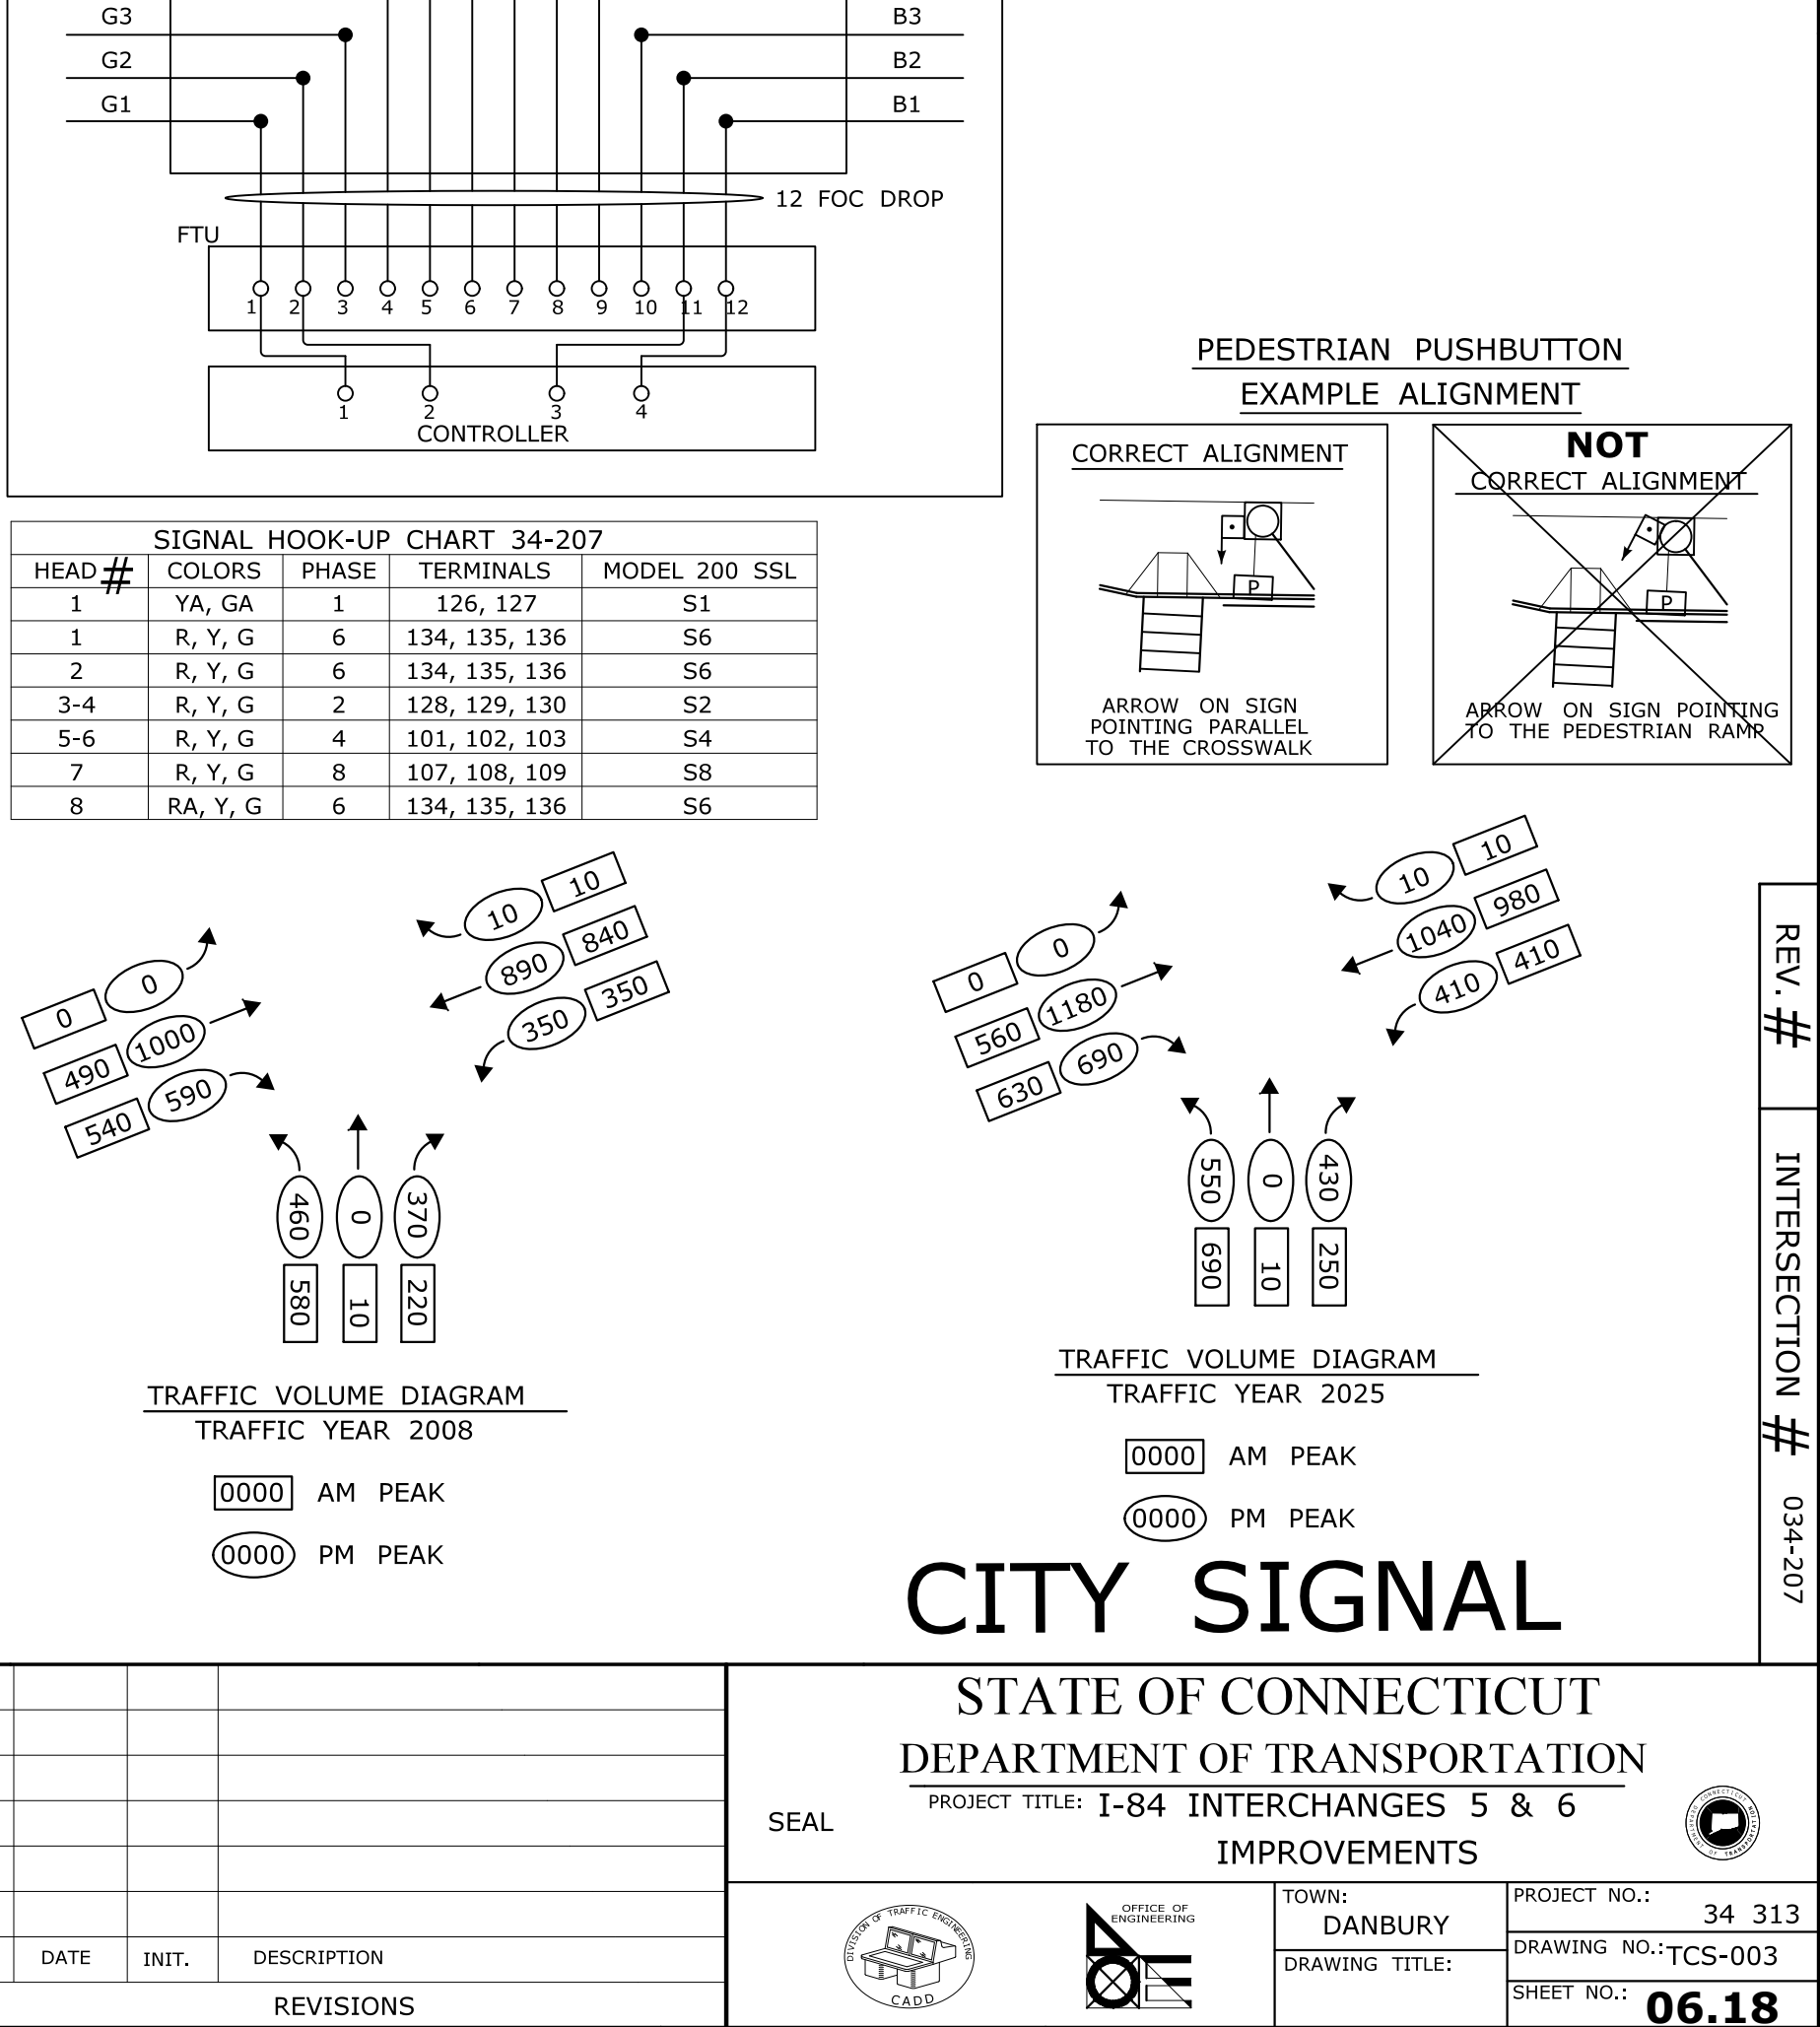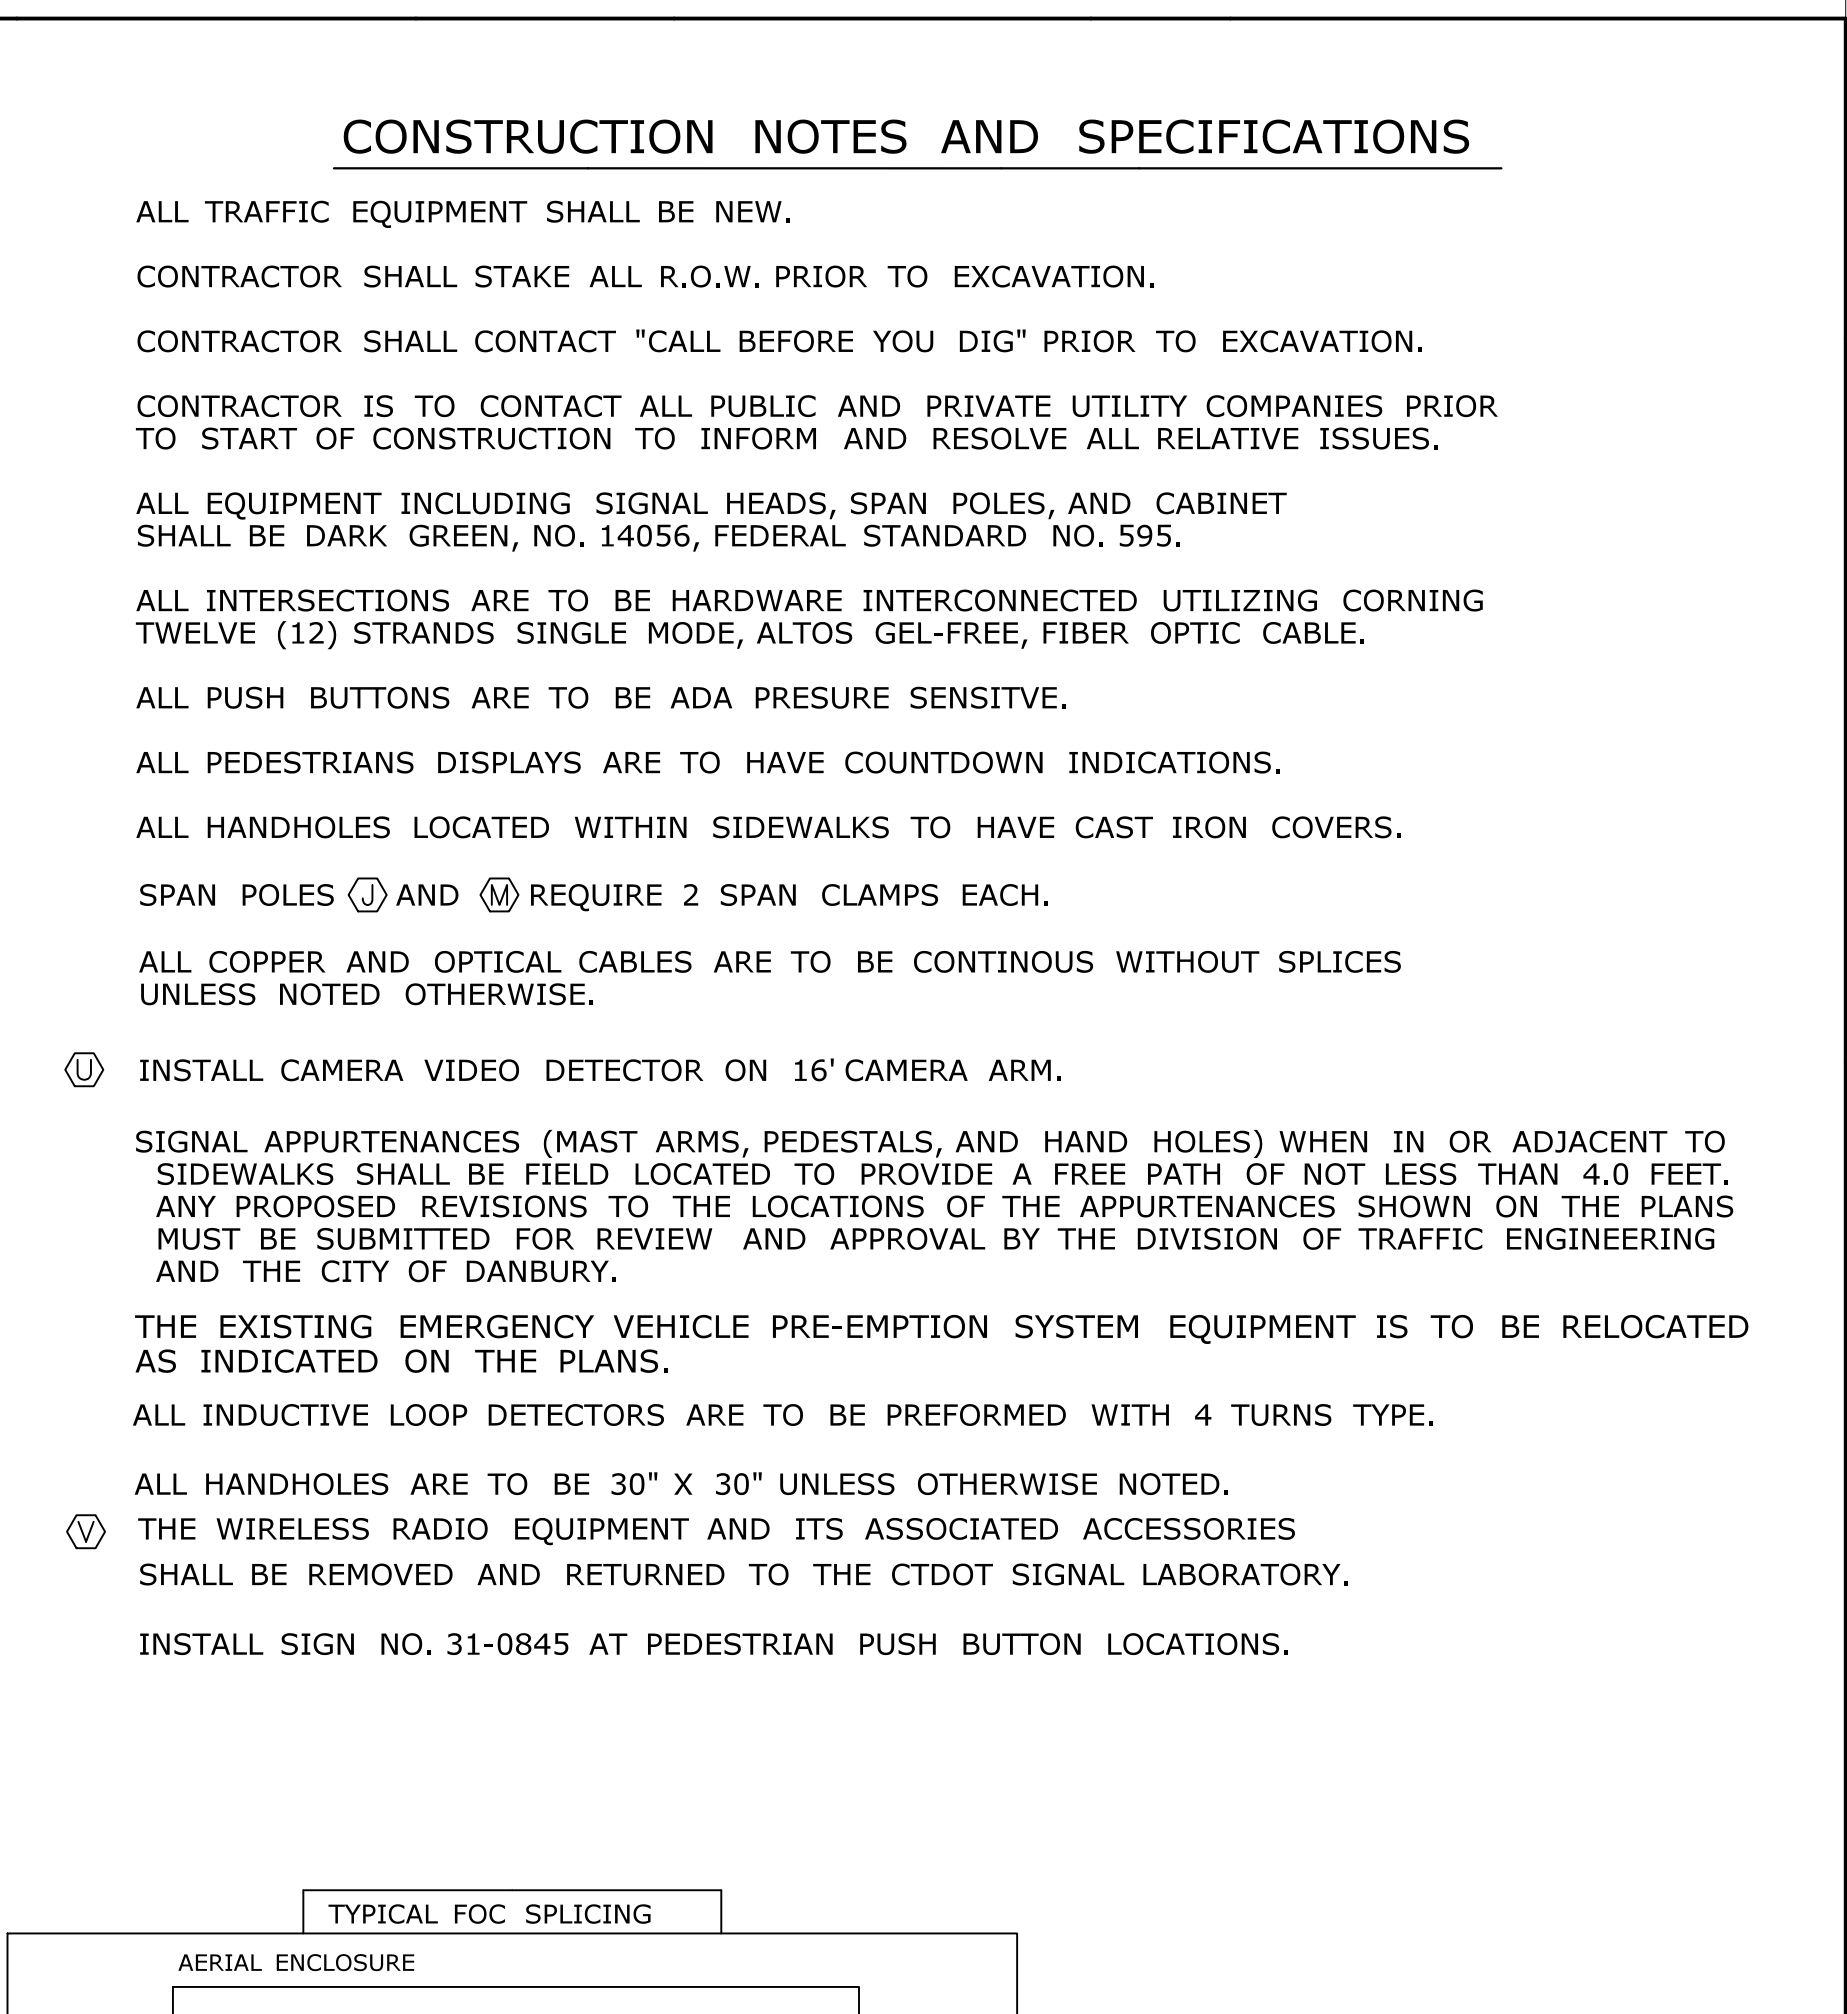



NONE		PRE-EMPT 1			MOVEMENT DIAGRAM			PRE-EMPT 1			PRE-EMPT 2			ENERGY BY CITY			METER # N/A			INTERSECTION # 034-227																																							
		MAINT LEVEL N/A			SP- CL&P 2376																																																						
UNMETERED SERVICE																																																											
OFFICE RECORD																																																											
REVISION #																																																											
SM #																																																											
SIGNAL REVISED:																																																											
INSTALL INTERCONNECT CABLE, NEW CABINET, AND NEW CONTROLLER.																																																											
TRANSFERRED OWNERSHIP TO CITY. ADDED EMERGENCY VEHICLE PRE-EMPTION																																																											
UNDER PROJECT 34-313.																																																											
SIGNAL FACES																																																											
<div><div><div><div>12"</div><div>12"</div><div>12"</div><div>12"</div></div><div><div><div><div>R</div><div>Y</div><div>G</div></div><div><div>←Y</div><div>Y</div><div>G</div></div></div><div>1,5</div></div><div><div><div><div>R</div><div>Y</div><div>G</div></div><div><div>←Y</div><div>Y</div><div>G</div></div></div><div>2,3,4,6,7</div></div><div><div><div><div>R</div><div>Y</div><div>G</div></div><div><div>Y</div><div>→Y</div><div>G</div></div></div><div>8</div></div><div><div><div><div>R</div><div>Y</div><div>G</div></div><div><div>Y</div><div>→</div><div>G</div></div></div><div>9</div></div><div><div><div><div>R</div><div>Y</div><div>G</div></div><div><div>Y</div><div>→Y</div><div>G</div></div></div><div>P4, P6</div></div></div><div>ALL INDICATIONS TO HAVE LED LAMPS. FACE 9 TO HAVE TUNNEL VISORS.</div><div>BI-COLORED YELLOW OR GREEN</div></div>																																																											
PRE-EMPTION SETTINGS																																																											
<table><tr><th></th><th>PRE-EMPT 1</th><th>PRE-EMPT 2</th></tr><tr><td>PRIORITY</td><td>NO</td><td>NO</td></tr><tr><td>DET. LOCK</td><td>YES</td><td>YES</td></tr><tr><td>DELAY</td><td>0</td><td>0</td></tr><tr><td>ALT. MIN. GRN</td><td>5</td><td>5</td></tr><tr><td>ALT. YELLOW</td><td>PARENT</td><td>PARENT</td></tr><tr><td>ALT. RED</td><td>PARENT</td><td>PARENT</td></tr><tr><td>ALT. PED. CLR.</td><td>19</td><td>19</td></tr><tr><td>HOLD GREEN</td><td>15</td><td>15</td></tr><tr><td>HOLD YELLOW</td><td>3.6</td><td>3</td></tr><tr><td>HOLD RED</td><td>1.0</td><td>1.0</td></tr><tr><td>HOLD PHASE</td><td>185</td><td>9</td></tr><tr><td>EXIT PHASE</td><td>285</td><td>185</td></tr><tr><td>EXIT CALL</td><td>NONE</td><td>NONE</td></tr></table>																			PRE-EMPT 1	PRE-EMPT 2	PRIORITY	NO	NO	DET. LOCK	YES	YES	DELAY	0	0	ALT. MIN. GRN	5	5	ALT. YELLOW	PARENT	PARENT	ALT. RED	PARENT	PARENT	ALT. PED. CLR.	19	19	HOLD GREEN	15	15	HOLD YELLOW	3.6	3	HOLD RED	1.0	1.0	HOLD PHASE	185	9	EXIT PHASE	285	185	EXIT CALL	NONE	NONE
	PRE-EMPT 1	PRE-EMPT 2																																																									
PRIORITY	NO	NO																																																									
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HOLD PHASE	185	9																																																									
EXIT PHASE	285	185																																																									
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BUREAU OF ENGINEERING & HWY OPERATIONS																																																											
DIVISION OF TRAFFIC ENGINEERING																																																											
TRAFFIC CONTROL SIGNAL																																																											
CITY OF DANBURY																																																											
ROUTE 37 (NORTH STREET) AT																																																											
BALMFORTH AVENUE AND																																																											
SHOPPING CENTER DRIVE																																																											
REV #																																																											
TRAFFIC																																																											
ELECTRICAL																																																											
ENGINEER																																																											
DRAWN BY																																																											
CHECKED BY																																																											
SUBMITTED BY																																																											
APPROVED BY																																																											
DATE																																																											

CONSTRUCTION NOTES :

ALL TRAFFIC SIGNAL EQUIPMENT IS EXISTING EXCEPT AS NOTED.

Ⓜ INSTALL INTERCONNECT CABLE AS SHOWN.

Ⓝ MODIFY EXISTING CONTROLLER FOUNDATION, INSTALL ADAPTER, 332D CABINET AMD 2070E CONTROLLER.

Ⓞ INSTALL VDS CABLE.

Ⓟ INSTALL AERIAL FOC ENCLOSURE.

Ⓠ INSTALL 2"RMC.

Ⓡ INSTALL 14/2.

Ⓚ INSTALL 2-14/2.

Ⓛ INSTALL MESSENGER, 14/2.

Ⓤ INSTALL 2"RMC RISER.

Ⓥ INSTALL 2-VDS CABLE.

Ⓦ INSTALL TYPE II HANDHOLE.

Ⓧ INSTALL LOOP DETECTOR.

Ⓨ INSTALL 2-VIDEO DETECTION CAMERA ON 20' PEDESTAL.

Ⓩ INSTALL 20/3 OPTICAL DETECTOR CABLE.

ALL COPPER AND OPTICAL CABLES ARE TO BE CONTINUOUS WITHOUT SPLICES UNLESS OTHERWISE NOTED.

CABINET AND ADAPTER SHALL BE DARK GREEN, NO. 14056, FEDERAL STANDARD NO. 595.

ALL PUSH BUTTONS ARE TO BE ADA PRESSURE SENSITIVE


ALL PEDESTRIAN DISPLAYS ARE TO HAVE COUNTDOWN INDICATIONS.

CITY SIGNAL

STATE OF CONNECTICUT
DEPARTMENT OF TRANSPORTATION
BUREAU OF ENGINEERING & HWY OPERATIONS
DIVISION OF TRAFFIC ENGINEERING
TRAFFIC CONTROL SIGNAL

CITY OF DANBURY
ROUTE 37 (NORTH STREET) AT
BALMFORTH AVENUE AND
SHOPPING CENTER DRIVE

REV #	TRAFFIC	ELECTRICAL
ENGINEER	DATE	DATE
DRAWN BY		
CHECKED BY		
SUBMITTED BY		
APPROVED BY		
DATE		

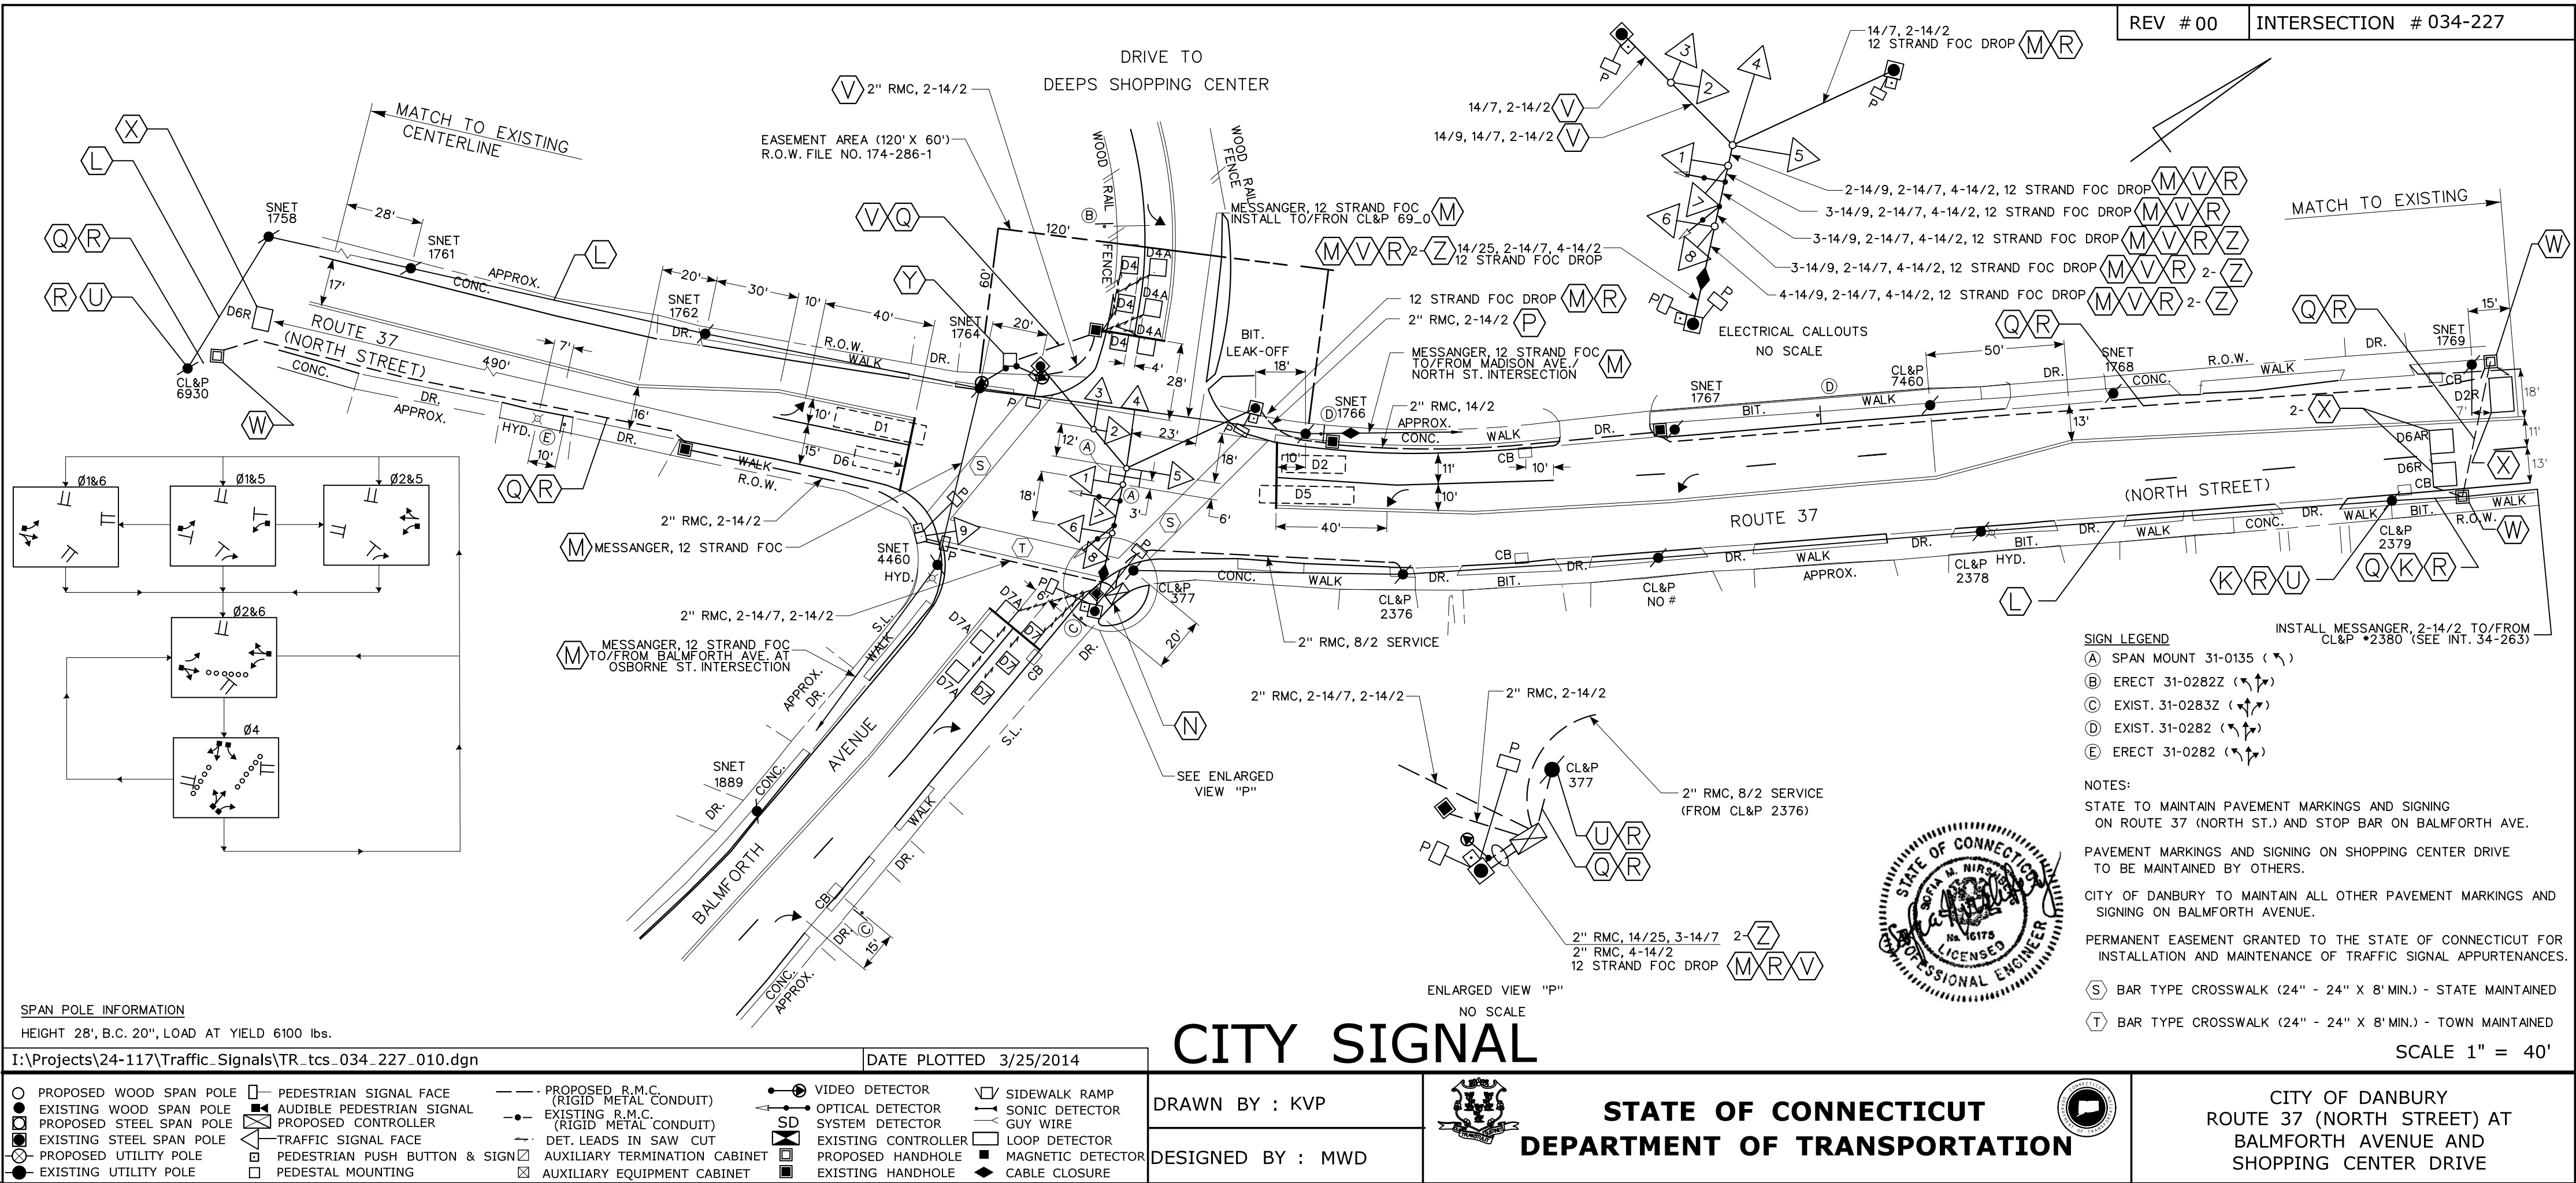


SIGNAL HOOKUP CHART 34-227				
HEAD #	PHASE	COLORS	TERMINALS	
1	1	YA,GA	126,127	
1	6	R,Y,G	134,135,136	
2	2	R,Y,G	128,129,130	
3	4	R,Y,G	101,102,103	
4	4	R,Y,G	101,102,103	
5	5	YA,GA	132,133	
5	2	R,Y,G	128,129,130	
6	6	R,Y,G	134,135,136	
7	4	R,Y,G	101,102,103	
8	5	YA,GA	132,133	
8	4	R,Y,G	101,102,103	
9	5	YA,GA	132,133	
9	2	R,Y,G	128,129,130	
P4	4P	DW,W	104,106	
P6	6P	DW,W	119,121	

DETECTOR ASSIGNMENT CHART				
IDENT	SLOT	PHASE	FUNCTION	C1-PIN
D1	11	1	CE	55
D2	12U	2	CE	39
D2R	13U	2	CES	43
D4	17U	4	CE	65
D4A	17L	4	CE	78
D5	31	5	CE	56
D6	32U	6	CE	40
D6R	33U	6	CES	64
D7	16U	4	CE	41
D7A	16L	4	CE	45

FIBER OPTIC CABLE COLOR CODE		
CABLE TO/FROM	COLOR	
CITY INT. NO.3012 OSBORNE ST @ BALMFORTH AVE	GREEN	
INT. NO. 34-263	BLUE	
CONTROLLER	RED	

SIGNAL HOOKUP CHART 34-227			
FROM/TO		FROM/TO	
FOC COLOR	FOC STRAND	FOC COLOR	FOC STRAND
GREEN	1-6	RED	1-6
BLUE	1-6	RED	7-12
NOTE: GREEN/BLUE 7-12 TO PASS THROUGH WITHOUT SPLICING			

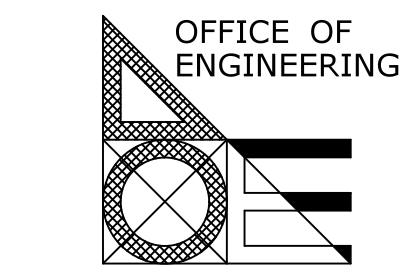

TOWN:


**DANBURY
TOWN NAME 2**

DRAWING TITLE:
**TRAFFIC CONTROL SIGNAL
DRAWING TITLE 2**

PROJECT NO.
34-313

DRAWING NO.
TCS-005

SHEET NO.
06.20

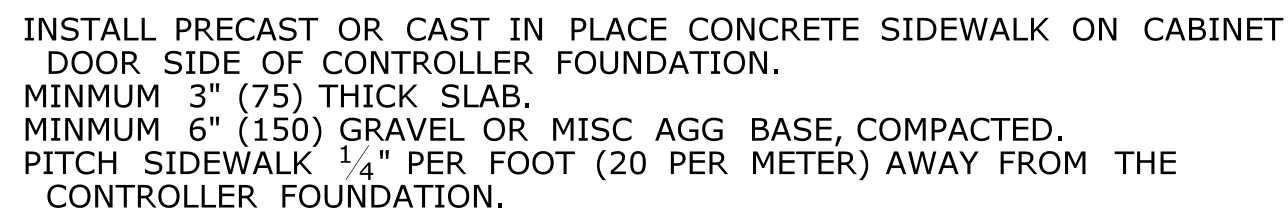



Isometric view of the 150 DP unit. Dimensions and callouts include:

- Top surface: 40 ³/₄" HOLES (1035), 9" (230), 18 ¹/₂" HOLES (462.5), 14" (355), 9" (230), 12" (300), 9" (230), 3" MIN (230), 3" (75) ANCHOR INSERT 4 PLCS.
- Front face: 1 ¹/₈" DIA x 6" DP (28 DIA x 150 DP) LIFT HOLES TYP 4 PLCS, 48" (1200), 34" (600), 32" (560), 8" (230), 9" (230) TYP, 6 ³/₄" (170) TYP, 8" (200) TYP, 1 ¹/₄" (30) KNOCK OUT TYP 6 PLCS, 22 ¹/₂" (570) TYP 4 PLCS, 18 ^{1/₂" (470), 6" (150) TYP, 1 ¹/₂" (40).}
- Side face: 11" (275), 15" (375), 30" (760), 7 ¹/₂" (190), 54" (1350), 7 ¹/₂" (190), 15" TYP (380), 11" TYP (280), 6" (150) TYP.
- Bottom face: 7 ³/₄" (195), 1 ¹/₂" RGS LARGE RADIUS 90 DEGREE ELBOW. INSTALL IN FIELD THRU 4" DIA OPENING.

NOTES:

INSTALL FOUNDATION ON 6" (150) OF COMPACTED GRAVEL IN ACCORDANCE WITH SECTION 2.14.
LEVEL FOUNDATION WITH A PROJECTION OF 4" (100) ABOVE FINISHED GRADE.
INSTALL COPPER GROUND ROD: 5/8" x 10 (16 x 3000).
PLACE NO. 6 CRUSHED STONE IN THE CENTER OPENINGS AFTER THE CONDUITS AND GROUND ROD
HAVE BEEN INSTALLED. THE OPENINGS SHALL BE CAPPED WITH A 2" (50) GROUT LEVEL WITH THE
TOP OF THE FOUNDATION AND NEATLY FINISHED. THE GROUT SHALL CONFORM WITH THE
REQUIREMENTS OF ARTICLE M.3.01-12.
CONCRETE: CLASS "F" 4000 PSI
#4 REBAR 2" (50) MIN COVER AROUND ALL OPENINGS, 3-#4 REBARS IN EACH CORNER.
CONDUITS SHALL NOT PROJECT MORE THAN 2" (50) ABOVE FOUNDATION.

LEGEND AS SHOWN ON TRAFFIC CONTROL SIGNAL PLAN: <div><div><div></div><div>PROPOSED CONTROLLER</div></div><div><div><div></div><div>EXISTING CONTROLLER</div></div><div><div></div><div>PROPOSED STEEL SPAN POLE</div></div><div><div><div></div><div>EXISTING STEEL SPAN POLE</div></div></div></div></div>				CONTROLLER - TYPE V - PRECAST					
		THE INFORMATION, INCLUDING ESTIMATED QUANTITIES OF WORK, SHOWN ON THESE SHEETS IS BASED ON LIMITED INVESTIGATIONS BY THE STATE AND IS IN NO WAY WARRANTED TO INDICATE THE CONDITIONS OF ACTUAL QUANTITIES OF WORK WHICH WILL BE REQUIRED.		DESIGNER/DRAFTER: M. DION		<div><div><div><div><div></div><div>STATE OF CONNECTICUT</div><div>DEPARTMENT OF TRANSPORTATION</div></div><div><div><div></div><div>ENGINEER: AECOM USA INC. / VN ENGINEERS, Inc.</div><div>APPROVED BY: SOFIA NIRSBERG, PE DATE: 03/28/2014</div></div></div></div><div><div><div></div><div>STATE OF CONNECTICUT</div><div>DEPARTMENT OF TRANSPORTATION</div></div><div><div><div></div><div>PROFESSIONAL ENGINEER</div><div>0610178</div></div></div></div></div></div>			
				CHECKED BY: R. GOMEZ					
				ENGINEER: AECOM USA INC. / VN ENGINEERS, Inc.					
REV. DATE REVISION DESCRIPTION Filename: DANBURY TRAFFIC CONTROLLER FOUNDATION.dgn 3/25/2014 Border Version: 6				PROJECT TITLE: I-84 INTERCHANGES 5 & 6 IMPROVEMENTS		TOWN: DANBURY		PROJECT NO. 34-313	
						DRAWING TITLE: TRAFFIC CONTROL FOUNDATIONS		DRAWING NO. TCS-007	
								SHEET NO. 06.22	

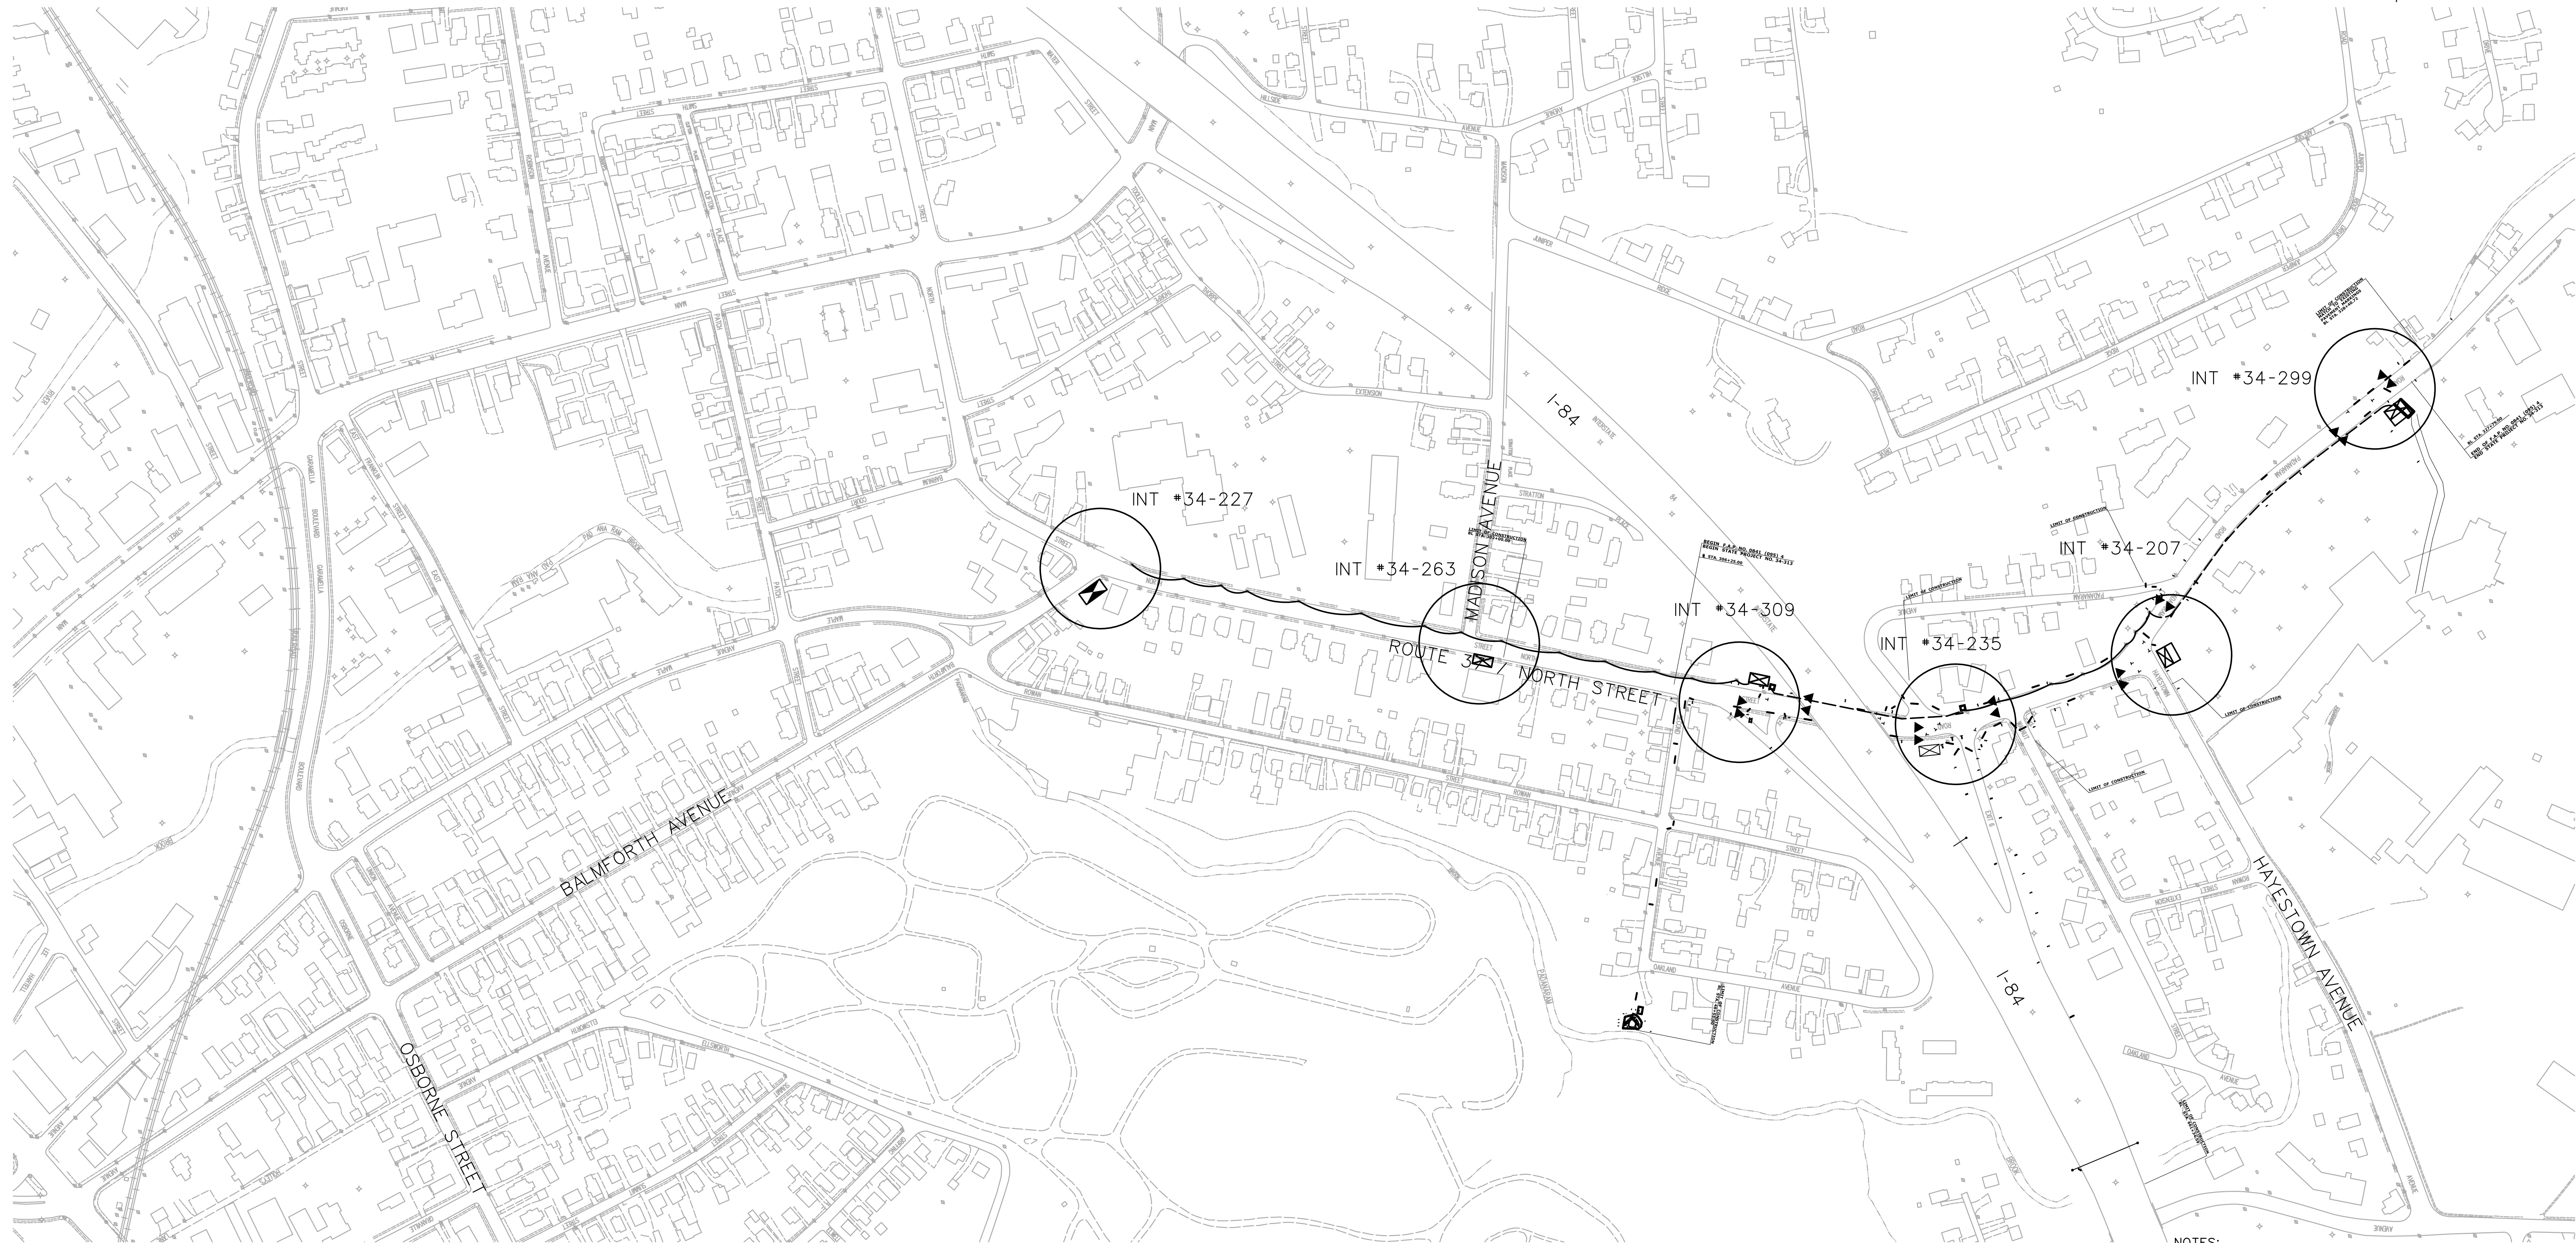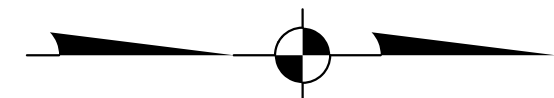

NOTES:

1. LOCATIONS OF HANDHOLES ARE APPROXIMATE. THE CONTRACTOR SHALL FIELD VERIFY EXACT LOCATION TO AVOID ANY CONFLICTS.
2. HANDHOLES AND CONDUITS SHALL BE INSTALLED WITHIN THE GRASS STRIP OR UNDER ROADWAY WITHIN STATE R.O.W. ALL HANDHOLES FOR INTERCONNECT SHALL BE 30" x 30".
3. SEE TRAFFIC SIGNAL SHEETS FOR ADDITIONAL INFORMATION.


LEGEND:

- ◄ SYSTEM DETECTOR
- ☒ PROPOSED CONTROLLER CABINET
- ☒ EXISTING CONTROLLER CABINET
- HAND HOLE (PULL BOX)
- 2" CONDUIT WITH 12 STRAND FIBEROPTIC CABLE
- 12 STRAND FIBER OPTIC CABLE INSTALLED OVERHEAD

REV.	DATE	REVISION DESCRIPTION	SHEET NO.
1	3/25/2014	Initial Design	6/17/14
2	03/28/2014	Revised Design	6/17/14

THE INFORMATION, INCLUDING ESTIMATED QUANTITIES OF WORK, SHOWN ON THESE SHEETS IS BASED ON LIMITED INVESTIGATIONS BY THE STATE AND IS IN NO WAY WARRANTED TO INDICATE THE CONDITIONS OF ACTUAL QUANTITIES OF WORK WHICH WILL BE REQUIRED.

DESIGNER/DRAFTER: M. DION
CHECKED BY: R. GOMEZ
SCALE IN FEET 0 200 400 SCALE 1"=200'

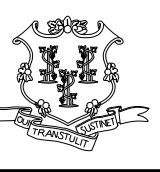


STATE OF CONNECTICUT
DEPARTMENT OF TRANSPORTATION

ENGINEER: **AECOM USA INC. / VN ENGINEERS, Inc.**

APPROVED BY: **SOPIA NIRSHBERG, PE**



DATE: 03/28/2014

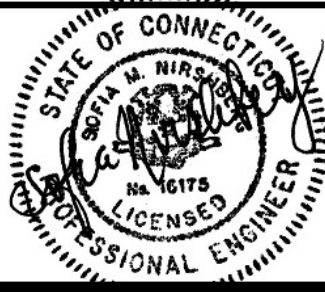

PROJECT TITLE: I-84 INTERCHANGES 5 & 6 IMPROVEMENTS

TOWN: DANBURY
DRAWING TITLE: SYSTEM INTERCONNECT PLAN

PROJECT NO. 34-313
DRAWING NO. INT-01
SHEET NO. 06.23

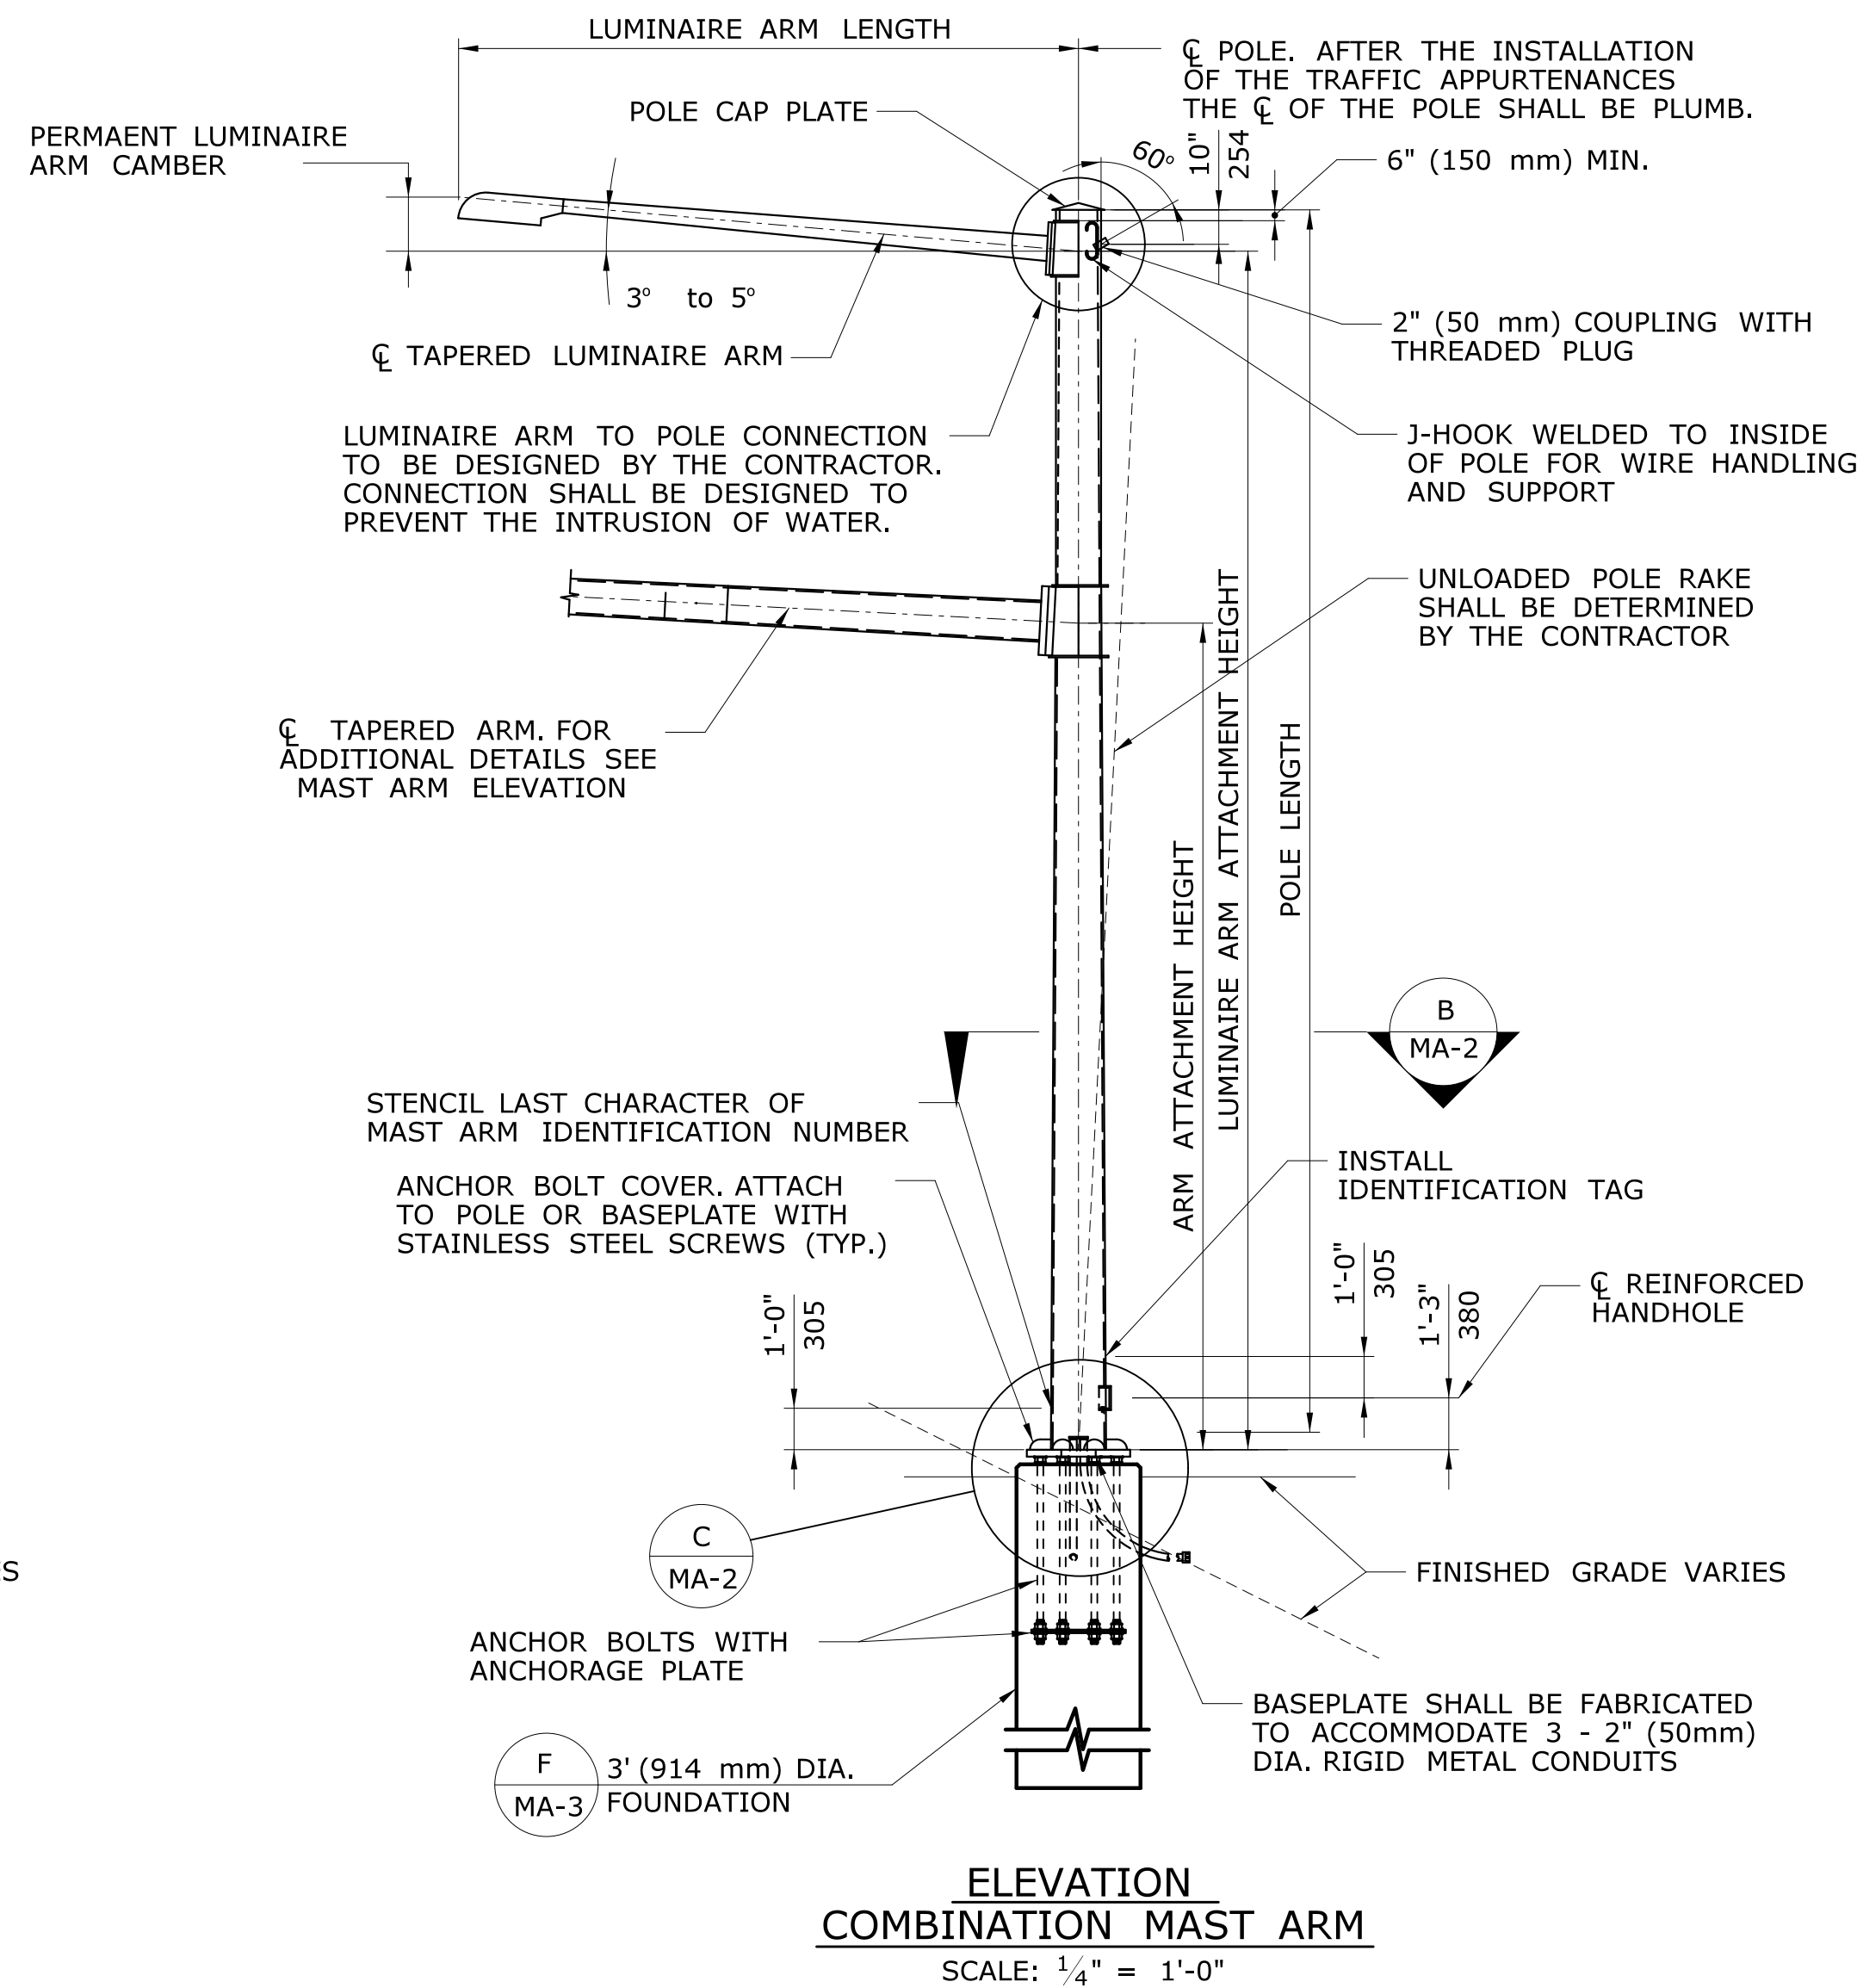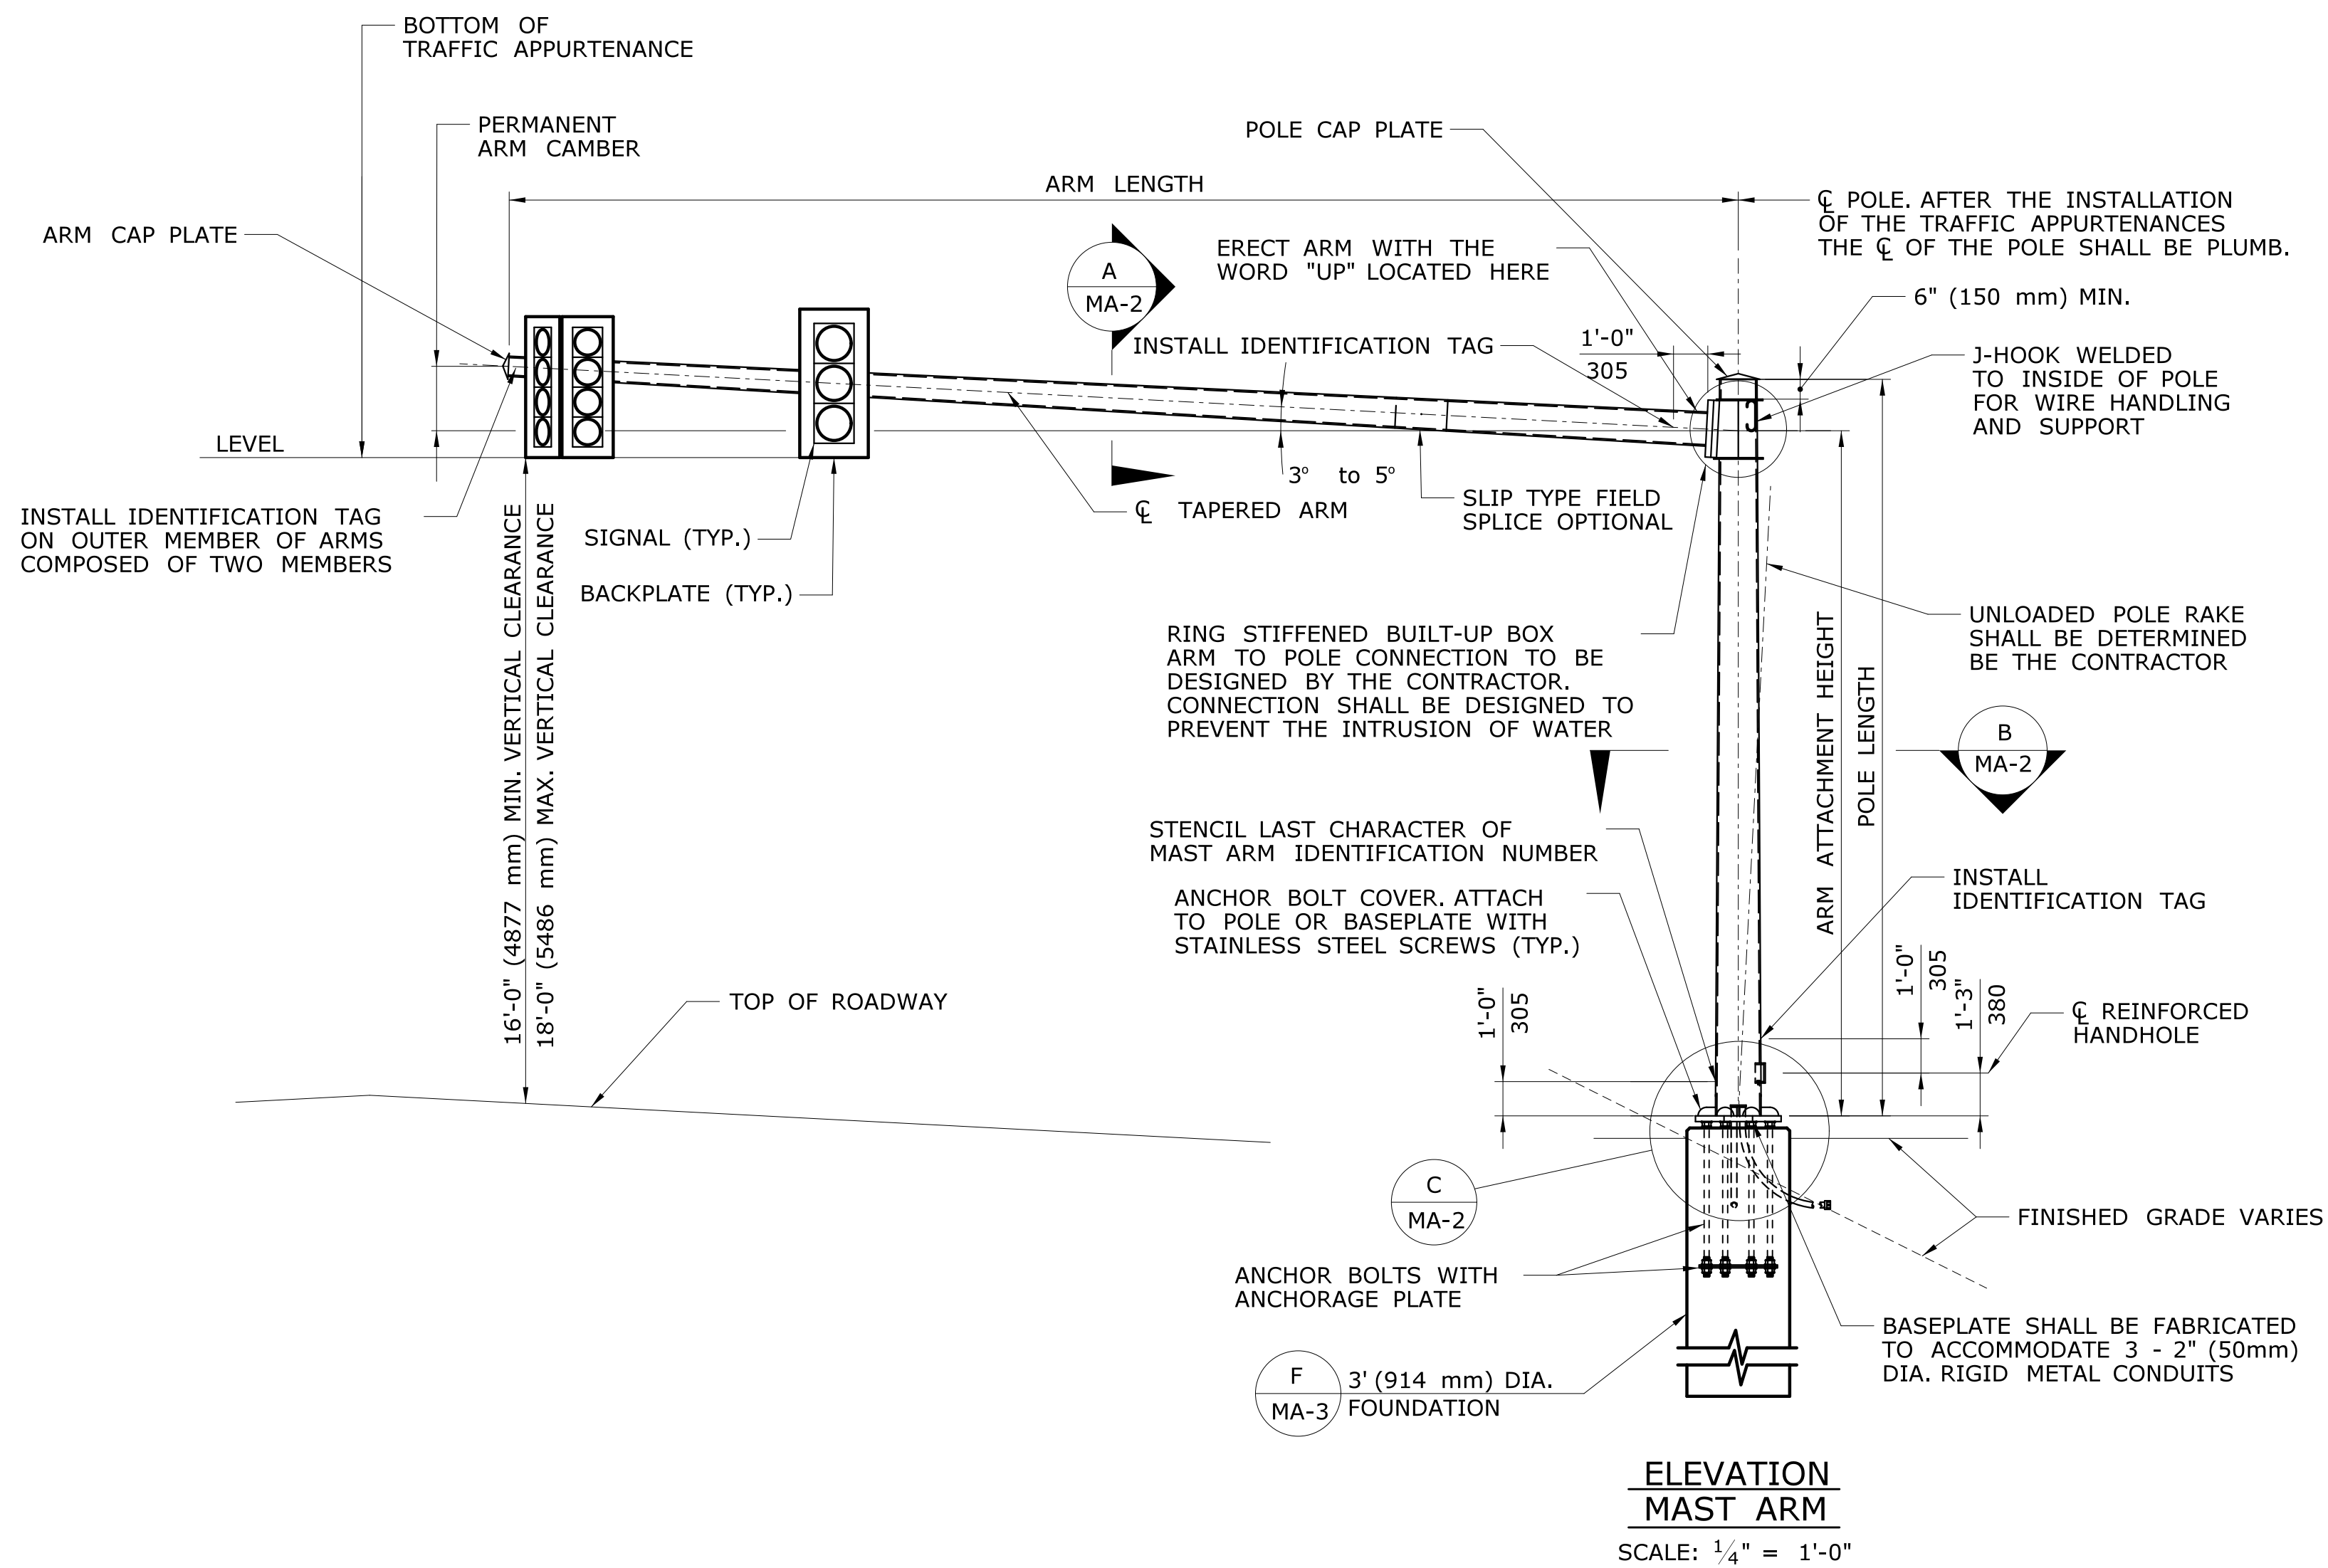

MAST ARM ASSEMBLY NOTES



THE MAST ARM, INCLUDING THE ANCHORAGE TO THE FOUNDATION, SHALL BE DESIGNED, FABRICATED AND INSTALLED BY THE CONTRACTOR, OF THE SPAN SPECIFIED, IN ACCORDANCE WITH THE SPECIAL PROVISION "XX STEEL MAST ARM ASSEMBLY" OR "XX STEEL COMBINATION MAST ARM ASSEMBLY".


THE DIMENSIONS OF THE MAST ARM ASSEMBLY AND DETAILS OF THE TRAFFIC APPURTENANCES SUPPORTED BY THE MAST ARM ASSEMBLY ARE SHOWN ON THE TRAFFIC SIGNAL PLANS, ELEVATIONS, CROSS-SECTIONS OR IN THE SPECIAL PROVISIONS. THE ARM AND POLE LENGTHS AND THE ATTACHMENT HEIGHTS SHALL BE VERIFIED BY THE CONTRACTOR, BASED ON THE FINISHED GRADE AT THE SITE, TOP OF FOUNDATION ELEVATION, THE LOCATIONS OF OVERHEAD UTILITY CABLES AND THE TRAFFIC APPURTENANCE MOUNTING HEIGHTS. IF EITHER THE ARM OR POLE LENGTH IS INADEQUATE, THE CONTRACTOR SHALL NOTIFY THE ENGINEER.

THE MAST ARMS SHALL BE DESIGNED IN ACCORDANCE WITH THE LATEST EDITION OF THE AASHTO STANDARD SPECIFICATIONS FOR STRUCTURAL SUPPORTS FOR HIGHWAY SIGNS, LUMINAIRES AND TRAFFIC SIGNALS, INCLUDING THE LATEST INTERIM SPECIFICATIONS, AS AMENDED BY THE AS SPECIAL PROVISION "XX STEEL MAST ARM ASSEMBLY" OR "XX STEEL COMBINATION MAST ARM ASSEMBLY".






THE MAST ARM SHALL BE DESIGNED FOR THE LOAD EFFECTS DUE TO THE ACTUAL TRAFFIC APPURTENANCES (SIGNALS, SIGNS, LUMINAIRES, CAMERAS, ETC.). THE MAST ARMS SHALL ALSO BE DESIGNED FOR THE EFFECTS OF TRAFFIC APPURTENANCES DURING ALL STAGES OF CONSTRUCTION THAT MAY EXIST DURING THE PROJECT UNDER WHICH THE MAST ARMS ARE INSTALLED.

THE MAST ARMS SHALL BE DESIGNED TO SUPPORT TRAFFIC APPURTENANCES WITH PROPERTIES NO LESS THAN THOSE SHOWN IN THE TABLE ENTITLED "TRAFFIC APPURTENANCE PROPERTIES - MINIMUM DESIGN VALUES".

REV. DATE REVISION DESCRIPTION SHEET NO.			THE INFORMATION, INCLUDING ESTIMATED QUANTITIES OF WORK, SHOWN ON THESE SHEETS IS BASED ON LIMITED INVESTIGATIONS BY THE STATE AND IS IN NO WAY WARRANTED TO INDICATE THE CONDITIONS OF ACTUAL QUANTITIES OF WORK WHICH WILL BE REQUIRED.		DESIGNER/DRAFTER: M. DION CHECKED BY: R. GOMEZ SCALE IN FEET SCALE 1" = 40'		STATE OF CONNECTICUT DEPARTMENT OF TRANSPORTATION  ENGINEER: AECOM USA INC. / VN ENGINEERS, Inc. APPROVED BY: SOPIA NIRSHBERG, PE DATE: 03/28/2014				PROJECT TITLE: I-84 INTERCHANGES 5 & 6 IMPROVEMENTS		TOWN: DANBURY DRAWING TITLE: MAST ARM ASSEMBLY ELEVATION		PROJECT NO. 34-313 DRAWING NO. MA-1 SHEET NO. 06.24	
File name: XXXXXX_SB_MastArm.dgn 3/25/2014 Border Version: 6																

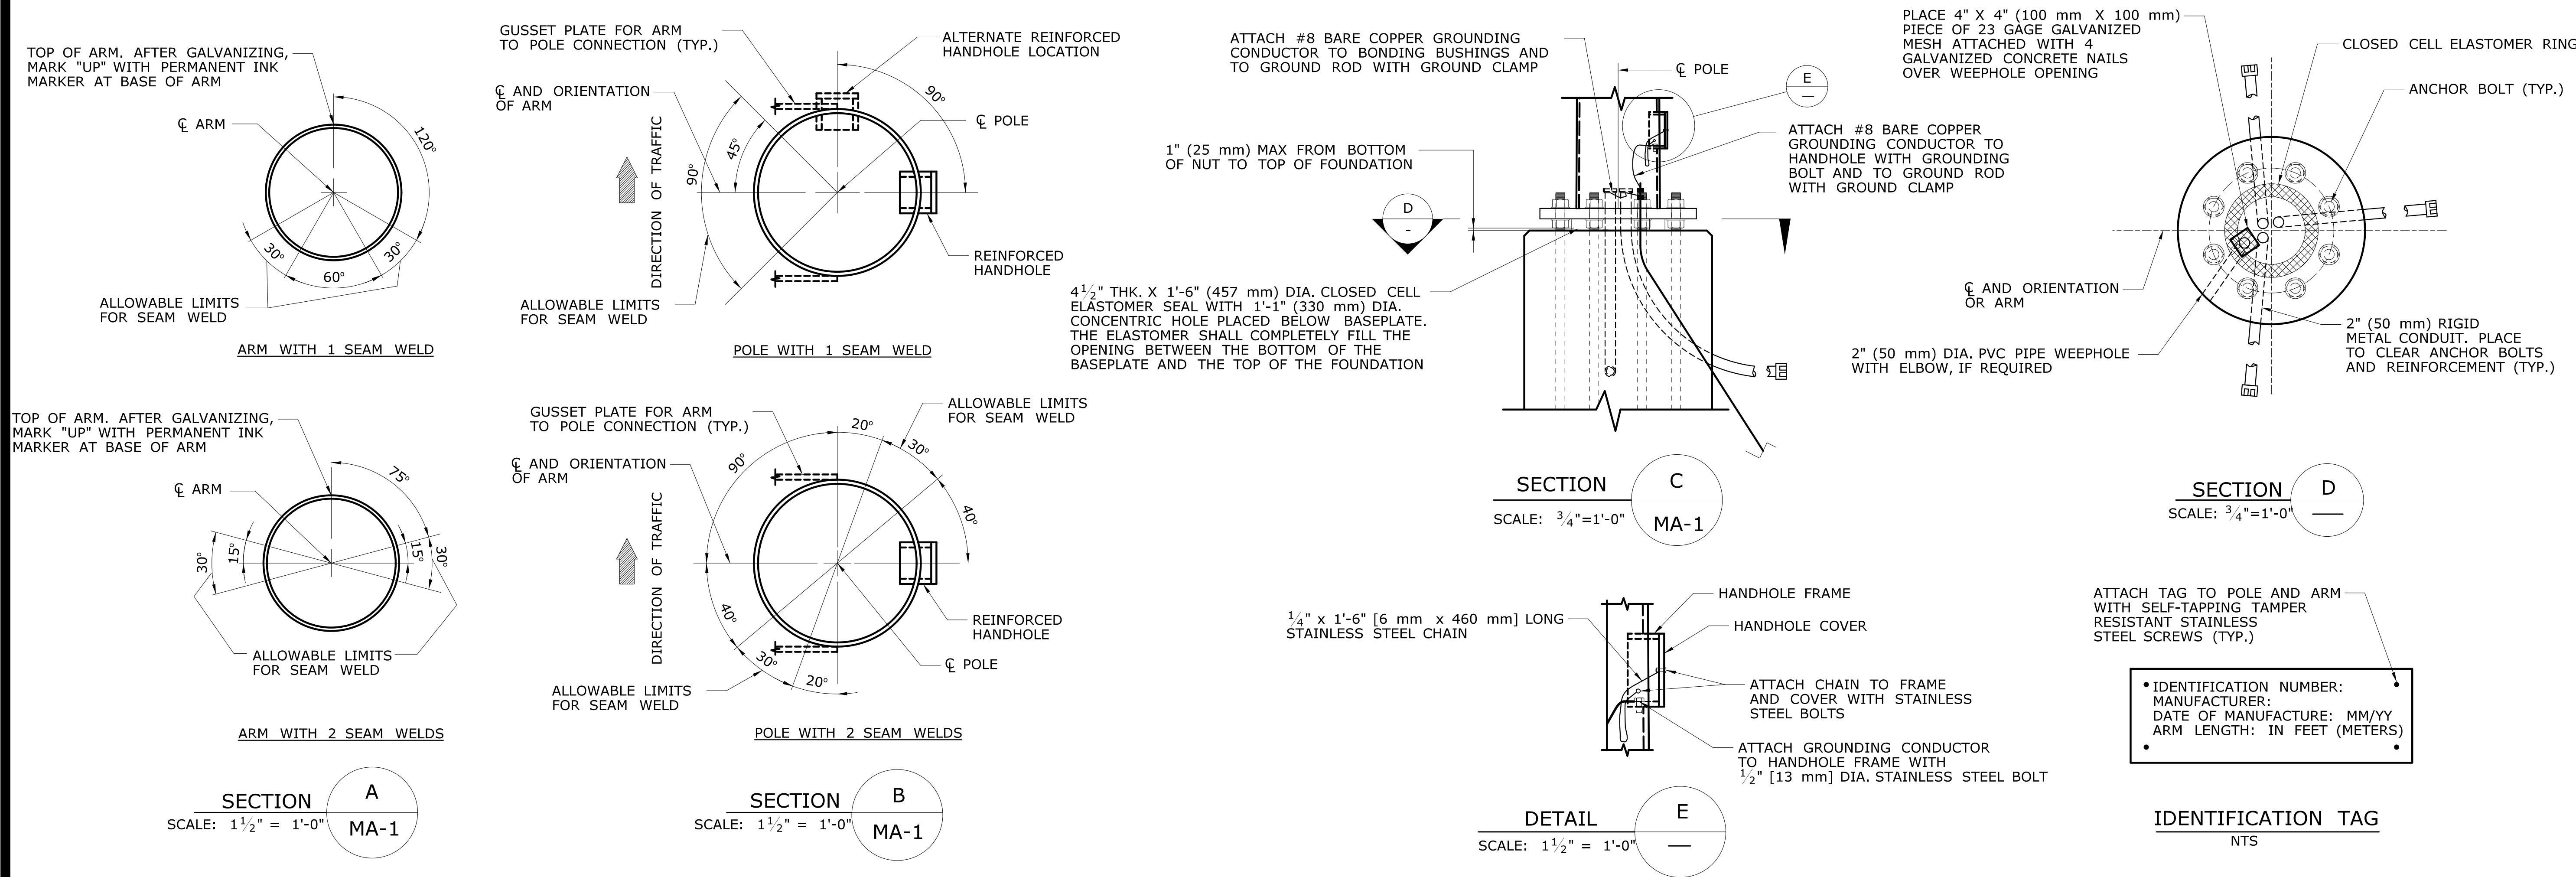

TRAFFIC APPURTENANCE PROPERTIES
MINIMUM DESIGN VALUES

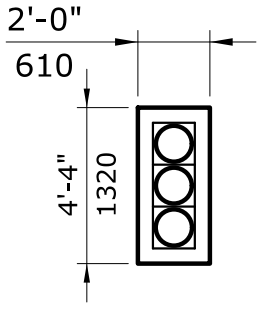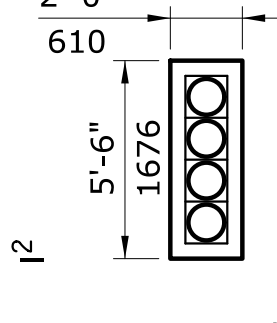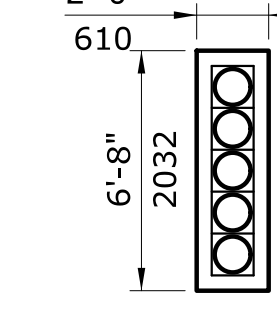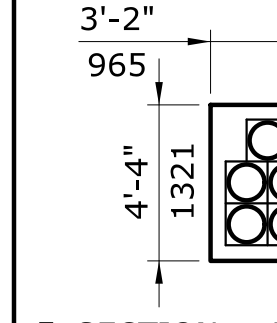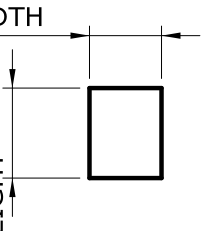	 2'-0" 610 4'-4" 1320 3 SECTION, 12" (305) DIA. TRAFFIC SIGNAL W/ BACKPLATE	 2'-0" 610 5'-6" 1676 4 SECTION, 12" (305) DIA. TRAFFIC SIGNAL W/ BACKPLATE	 2'-0" 610 6'-8" 2032 5 SECTION, 12" (305) DIA. TRAFFIC SIGNAL W/ BACKPLATE	 3'-2" 965 4'-4" 1321 5 SECTION, 12" (305) DIA. TRAFFIC SIGNAL W/ BACKPLATE	 WIDTH HEIGHT SHEET ALUMINUM SIGN PANEL
WEIGHT, INCLUDING MOUNTING HARDWARE	65 LBS (29.48 kg)	80 LBS (36.29 kg)	95 LBS (43.09 kg)	105 LBS (47.63 kg)	4 LBS/SQ.FT. (19.53 kg/m ²)
TOTAL SURFACE AREA	28.04 SQ. FT. (2.61 m ²)	35.46 SQ. FT. (3.29 m ²)	45.16 SQ. FT. (4.20 m ²)	41.04 SQ. FT. (3.81 m ²)	BASED ON PANEL DIMENSIONS
PROJECTED AREA, FRONT FACE	8.62 SQ. FT. (0.80 m ²)	10.91 SQ. FT. (1.01 m ²)	13.34 SQ. FT. (1.24 m ²)	13.72 SQ. FT. (1.28 m ²)	BASED ON PANEL DIMENSIONS
PROJECTED AREA, BOTTOM FACE	1.18 SQ. FT. (0.11 m ²)	1.18 SQ. FT. (0.11 m ²)	1.18 SQ. FT. (0.11 m ²)	2.58 SQ. FT. (0.24 m ²)	BASED ON PANEL DIMENSIONS

NOTES:

THE TABULATED VALUES ARE THE MINIMUM VALUES THAT SHALL BE USED FOR THE DESIGN.

MAST ARMS SHALL BE DESIGNED ASSUMING ALL TRAFFIC SIGNALS ARE COMPOSED OF 12" (305 mm) DIAMETER SECTIONS WITH BACKPLATES.

THE PROJECTED FRONT FACE AREA IS IN A PLANE PARALLEL TO THE PLANE FORMED BY THE ARM AND THE POLE.

IF MULTIPLE APPURTENANCES ARE ATTACHED AT THE SAME LOCATION, THE MINIMUM DESIGN VALUE SHALL BE NO LESS THAN THE SUM OF THE CORRESPONDING TRAFFIC APPURTENANCE PROPERTIES.


FOR TRAFFIC APPURTENANCES NOT SHOWN, THE PROPERTIES SHALL BE DETERMINED BY THE CONTRACTOR AND SUBMITTED FOR REVIEW WITH THE WORKING DRAWING SUBMITTAL.

REV.	DATE	REVISION DESCRIPTION	SHEET NO.
1	3/25/2014	Border Version	6/17/05

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DESIGNER/DRAFTER:
M. DION
CHECKED BY:
R. GOMEZ
SCALE IN FEET
0 40 80
SCALE 1"=40'

STATE OF CONNECTICUT
DEPARTMENT OF TRANSPORTATION
ENGINEER: **AECOM USA INC. / VN ENGINEERS, Inc.**
APPROVED BY: **SOFIA NIRSHBERG, PE**
DATE: 03/28/2014

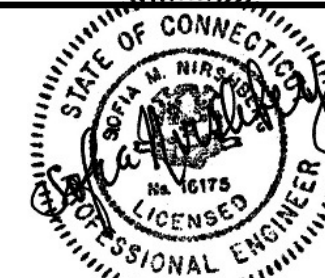

PROJECT TITLE:
I-84 INTERCHANGES 5 & 6 IMPROVEMENTS

TOWN:
DANBURY

DRAWING TITLE:
MAST ARM ASSEMBLY DETAILS

PROJECT NO.
34-313
DRAWING NO.
MA-2
SHEET NO.
06.25

FOUNDATION NOTES

THE MAST ARM FOUNDATION IS DESIGNED IN ACCORDANCE WITH THE LATEST EDITION OF THE AASHTO STANDARD SPECIFICATIONS FOR STRUCTURAL SUPPORTS FOR HIGHWAY SIGNS, LUMINAIRES AND TRAFFIC SIGNALS, WITH THE LATEST INTERIM SPECIFICATIONS.

THE FOUNDATION EMBEDMENT IS DESIGNED FOR MAXIMUM LOAD EFFECTS, APPLIED AT THE TOP OF THE FOUNDATION, NO GREATER THAN THE FOLLOWING:

AXIAL COMPRESSIVE FORCE:	K	(kN)
RESULTANT SHEAR FORCE:	K	(kN)
TORSION:	FT - K	(kN - m)
RESULTANT BENDING MOMENT:	FT - K	(kN - m)

THE USE OF THE FOUNDATION IS NOT PERMITTED IF THE COMPUTED REACTIONS FROM THE CONTRACTOR DESIGNED MAST ARM ASSEMBLY EXCEED THE ABOVE LOAD EFFECTS.

THE ENGINEER SHALL BE NOTIFIED IF THE SLOPE OF THE FINISHED GRADE AT THE FOUNDATION EXCEEDS THE MAXIMUM PERMITTED SLOPE.


THE CONCRETE FOR THE FOUNDATION SHALL CONFORM TO "CLASS "A" CONCRETE".

THE REINFORCEMENT SHALL BE UNCOATED AND CONFORM TO ASTM A615, GRADE 60 (ASTM A615M, GRADE 420). THE REINFORCEMENT SHALL BE ASSEMBLED WITH WIRE TIES. WELDING TO ASSEMBLE REINFORCEMENT IS NOT PERMITTED. ALL REINFORCEMENT SHALL HAVE 3" (75 mm) COVER, UNLESS OTHERWISE NOTED.

THE CONCRETE SHALL BE PLACED IN A AUGERED HOLE AGAINST UNDISTRURBED EARTH.



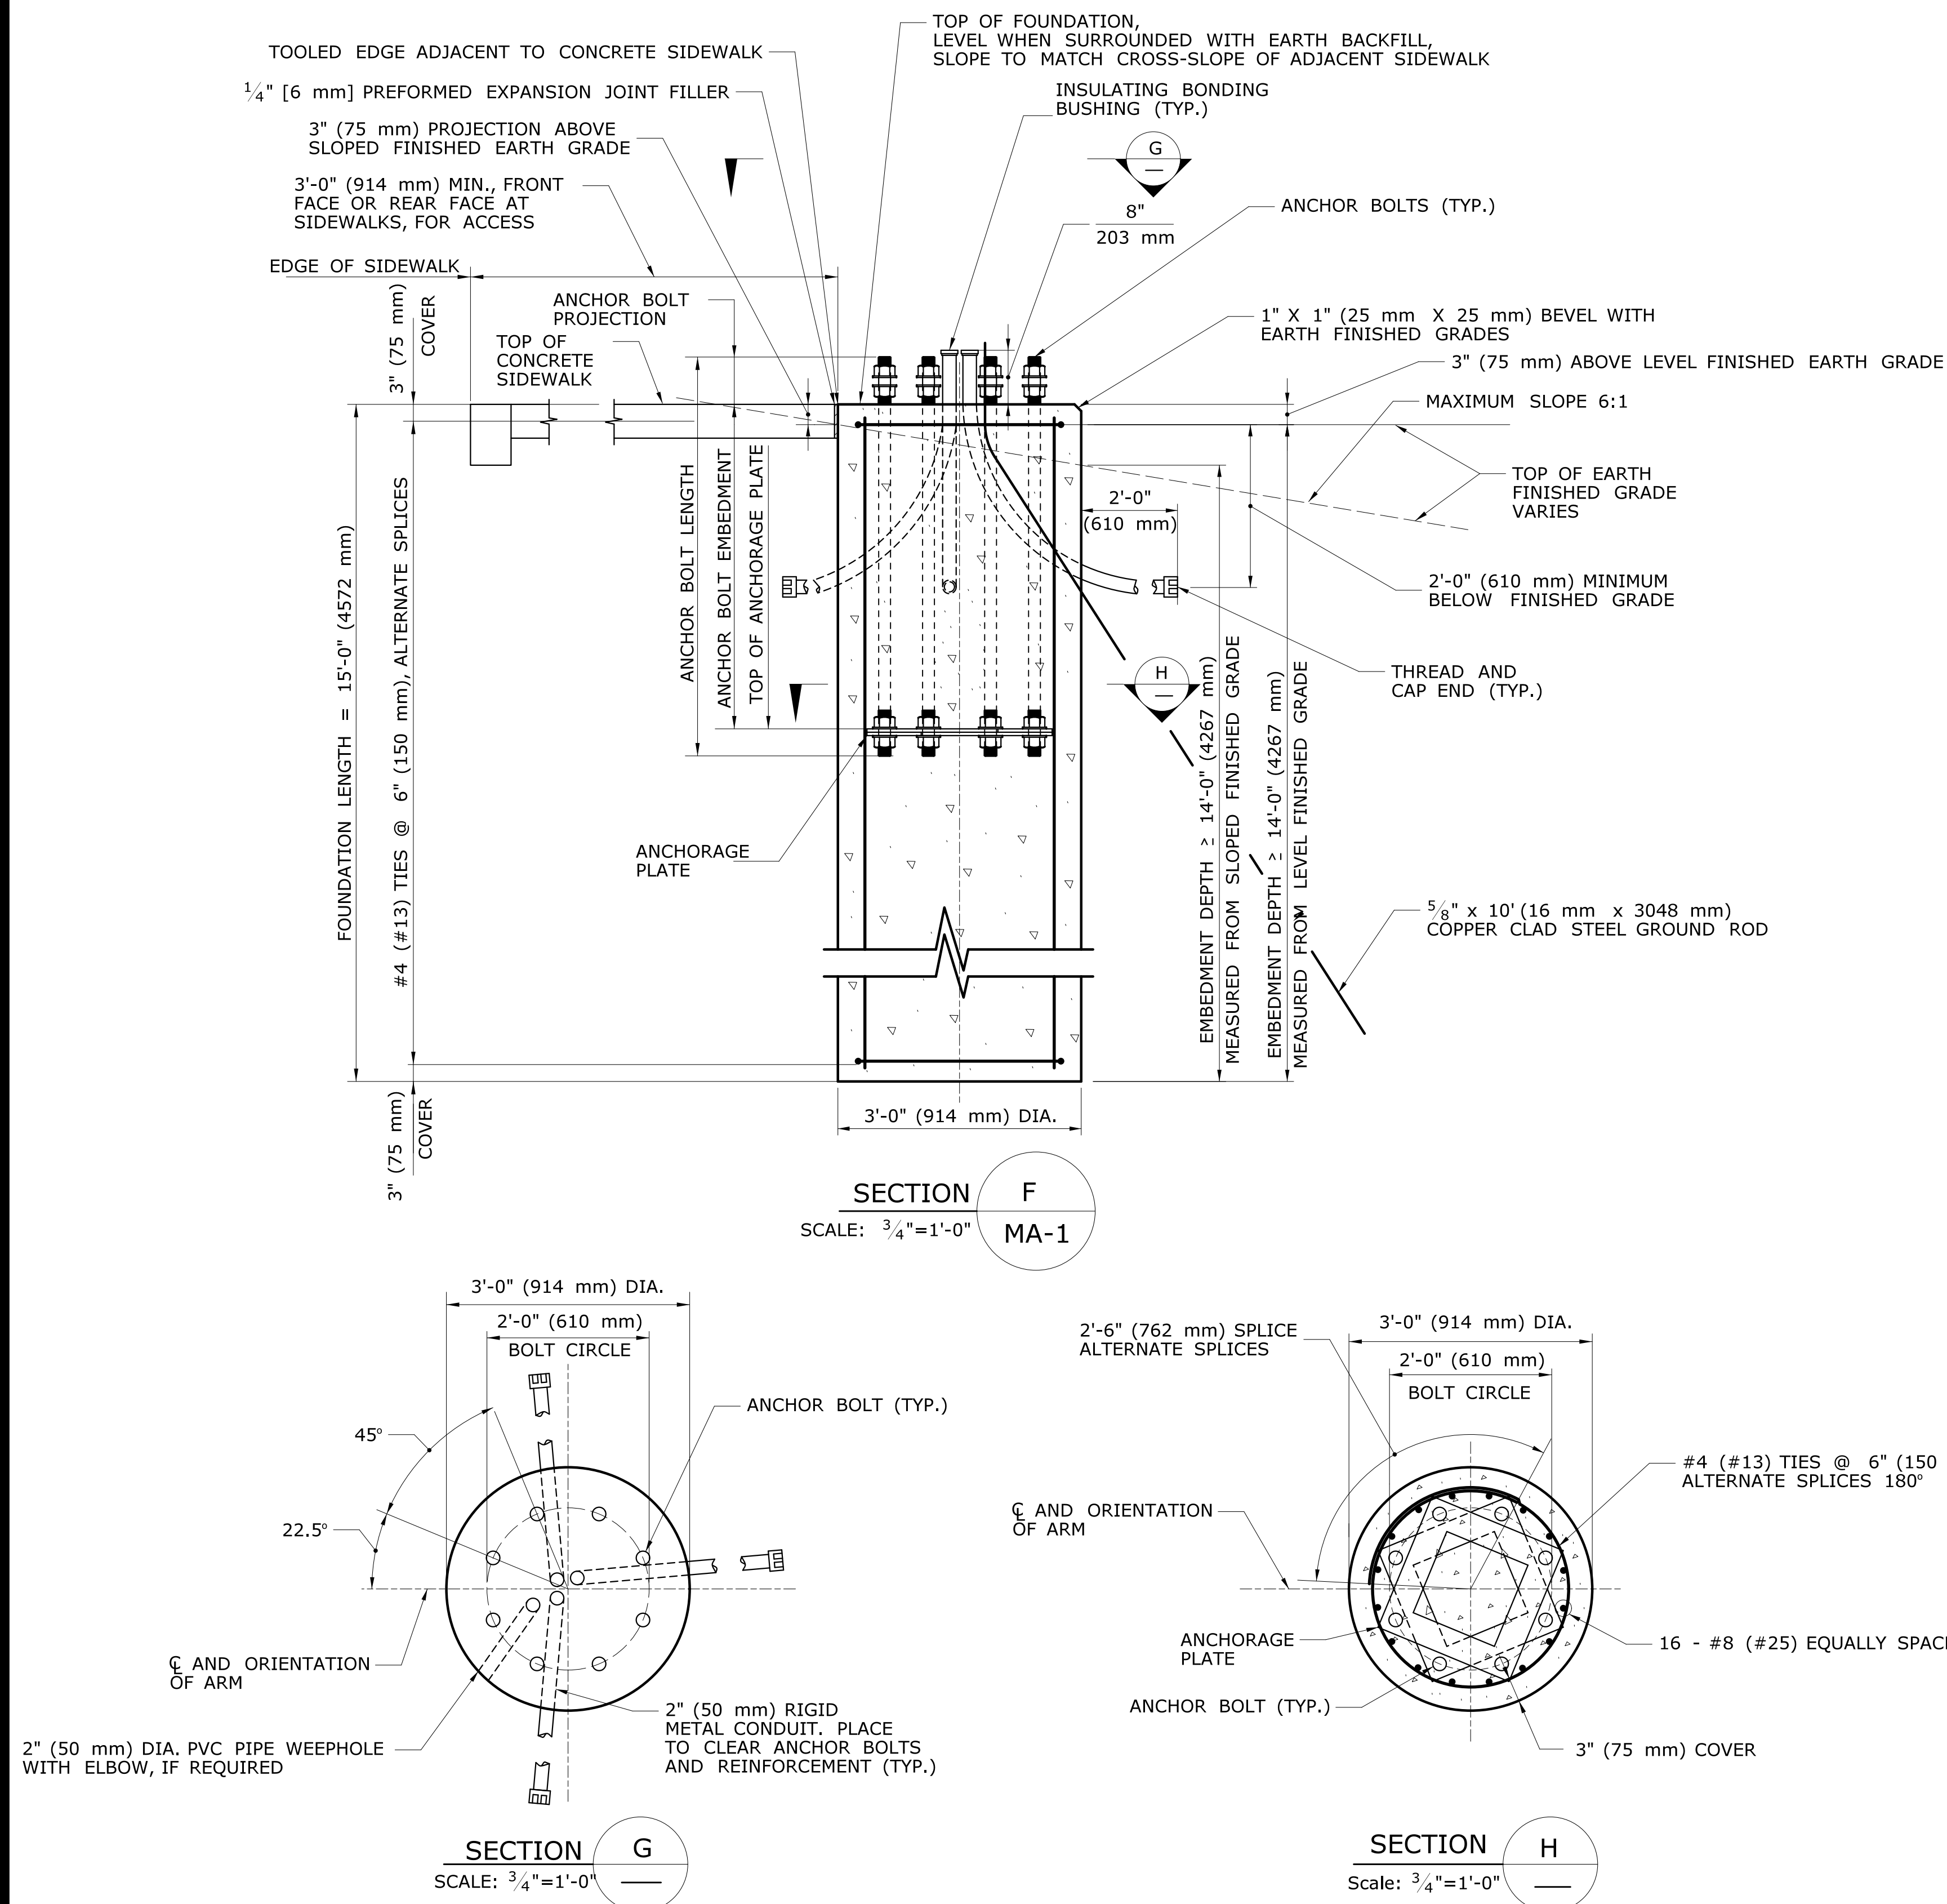

THE MAST ARM SHALL NOT BE ERECTED ON THE FOUNDATION UNTIL AFTER THE CONCRETE HAS ATTAINED A 28 DAY COMPRESSIVE STRENGTH, f'_c , GREATER THAN OR EQUAL TO 3000 PSI (21 MPa).

THE COST OF THE FOUNDATION, INCLUDING THE EXCAVATION, CONCRETE AND REINFORCEMENT, SHALL BE PAID FOR UNDER THE ITEM "TRAFFIC CONTROL FOUNDATION - MAST ARM".



ATTENTION USER:

THE USER OF THESE FOUNDATION DETAILS IS RESPONSIBLE FOR DETERMINING THE VALUES FOR THE MAXIMUM LOAD EFFECTS APPLIED AT THE TOP OF THE FOUNDATION AND ADDING THE VALUES TO THE ABOVE NOTES. THE USER SHALL ENSURE THAT THE FOUNDATION IS ONLY USED FOR MAST ARM ASSEMBLIES WITH COMPUTED REACTIONS THAT DO NOT EXCEED THESE MAXIMUM LOAD EFFECTS. THIS NOTE SHALL BE REMOVED, BY THE USER, PRIOR TO INCORPORATING THESE FOUNDATION DETAILS INTO THE CONTRACT DOCUMENTS.

			THE INFORMATION, INCLUDING ESTIMATED QUANTITIES OF WORK, SHOWN ON THESE SHEETS IS BASED ON LIMITED INVESTIGATIONS BY THE STATE AND IS IN NO WAY WARRANTED TO INDICATE THE CONDITIONS OF ACTUAL QUANTITIES OF WORK WHICH WILL BE REQUIRED.			DESIGNER/DRAFTER: M. DION CHECKED BY: R. GOMEZ SCALE IN FEET  SCALE 1" = 40'			STATE OF CONNECTICUT DEPARTMENT OF TRANSPORTATION 						PROJECT TITLE: I-84 INTERCHANGES 5 & 6 IMPROVEMENTS			TOWN: DANBURY			PROJECT NO. 34-313		
REV. DATE REVISION DESCRIPTION SHEET NO. FilenameXXXXXXXXX_SB_MastArm.dgn 3/25/2014 Border.Version: 6						ENGINEER: AECOM USA INC. / VN ENGINEERS, Inc. APPROVED BY: SOFIA NIRSBERG, PE DATE: 03/28/2014									DRAWING TITLE: MAST ARM ASSEMBLY FOUNDATION DETAILS			SHEET NO. MA-3 06.26					